GENERAL NOTES

- 1. CONTRACTOR TO ADHERE TO ALL CODES AND REGULATIONS GOVERNING CONSTRUCTION AND BUILDING ACCESS.
- 2. DRAWINGS SHALL NOT BE SCALED FOR DIMENSIONAL INFORMATION.

5. "PROVIDE" MEANS FURNISH AND INSTALL, COMPLETE AND IN PLACE.


- 3. "FURNISH" MEANS SUPPLY ONLY, FOR OTHERS TO PUT INTO PLACE.
- 4. "INSTALL" MEANS SUPPLIED BY OTHERS, TO BE INSTALLED BY THE CONTRACTOR.
- 6. "SIMILAR" MEANS COMPARABLE CHARACTERISTICS FOR CONDITIONS NOTED. CONTRACTOR TO VERIFY DIMENSIONS AND ORIENTATION.
- 7. "TYPICAL" MEANS IDENTICAL FOR CONDITIONS NOTED.
- 8. ALL WORK SHALL COMPLY WITH APPLICABLE CODES, AMENDMENTS, REGULATIONS, ORDINANCES, LAWS, ORDERS, APPROVALS, ETC. THAT ARE REQUIRED BY PUBLIC AUTHORITIES. IN THE EVENT OF CONFLICT, THE MOST STRINGENT REQUIREMENTS SHALL COMPLY. REQUIREMENTS INCLUDE, BUT ARE NOT LIMITED TO, THE CURRENT APPLICABLE EDITIONS OR PUBLICATIONS OF THE FOLLOWING (OR AS OTHERWISE NOTED):
 - A. CALIFORNIA BUILDING CODE

WHICHEVER IS MORE APPLICABLE.

- B. NATIONAL FIRE PROTECTION ASSOCIATION C. AMERICAN NATIONAL STANDARDS INSTITUTE
- D. NON-RESIDENTIAL MANUAL FOR COMPLIANCE WITHCALIFORNIA'S ENERGY EFFICIENCY STANDARDS
- E. TITLE 24 AND THE CALIFORNIA STATE BUILDING CODE 9. CONTRACTOR SHALL OBTAIN AND PAY FOR PERMITS AND INSPECTIONS REQUIRED BY PUBLIC AUTHORITIES GOVERNING THE WORK.
- 10. ALL WORK SHALL BE PERFORMED IN ACCORDANCE WITH PROCEDURES SET FORTH BY THE PROPERTY MANAGEMENT. SEE THE BUILDING'S CONTRACTOR REGULATIONS. WHEN SEPARATELY BOUND SPECIFICATIONS ACCOMPANY THESE DRAWINGS, THEY SHALL BE CONSIDERED PART OF THESE CONSTRUCTION DOCUMENTS.
- 11. CONTRACTOR TO MAINTAIN ALL PROPER WORKER'S COMPENSATION AND LIABILITY INSURANCE THROUGHOUT DURATION OF CONSTRUCTION
- 12. GENERAL CONTRACTOR SHALL REVIEW THE BASE BUILDING CONTRACT DOCUMENTS AND SHALL COMPLY WITH ALL BASE BUILDING REQUIREMENTS AND DESIGN CRITERIA. 13. ALL WORK ON PLANS TO BE NEW UNLESS OTHERWISE NOTED. ITEMS THAT ARE EXISTING TO REMAIN SHALL BE LABELED 'EXISTING', 'EXIST' OR '(E).' ALL PLAN NOTES IMPLY THE WORDS 'THE CONTRACTOR SHALL...' OR 'THE CONTRACTOR SHALL INSTALL...
- 14. GENERAL CONTRACTOR SHALL BE RESPONSIBLE FOR CHECKING CONTRACT DOCUMENTS, FIELD CONDITIONS AND DIMENSIONS FOR ACCURACY AND CONFIRMING THAT WORK IS AS SHOWN BEFORE PROCEEDING WITH CONSTRUCTION. CLARIFICATIONS REGARDING ANY CONFLICTS SHALL BE ACHIEVED PRIOR TO RELATED WORK BEING STARTED.
- 15. THE CONTRACTOR SHALL NOTIFY THE OWNER IN WRITING OF ANY DEFICIENCIES IN BASE BUILDING WORK PRIOR TO THE COMMENCEMENT OF HIS WORK. ANY UNREPORTED DEFICIENCIES WILL BECOME THE RESPONSIBILITY OF THE CONTRACTOR TO
- 16. ALL DIMENSIONS TAKE PRECEDENT OVER SCALE. THE CONTRACTOR SHALL NOT SCALE THE DRAWINGS WITH THE INTENT OF DETERMINING EXACT PLACEMENT OR LOCATION OF PARTICULAR ASSEMBLIES.
- 17. HORIZONTAL DIMENSIONS INDICATED ARE TO/FROM FINISHED FACE OF CONSTRUCTION, EXCEPT AS NOTED.
- 18. VERTICAL DIMENSIONS ARE FROM TOP OF FLOOR SLAB, EXCEPT WHERE NOTED TO BE FROM ABOVE FINISHED FLOOR (A.F.F.). 19. DIMENSIONS ARE NOT ADJUSTABLE WITHOUT APPROVAL OF ARCHITECT UNLESS NOTED.
- 20. CONTRACTOR SHALL "STRIKE OUT" LOCATION OF WALLS, DOORS, MULLIONS, SOFFITS, RAISED FLOOR GRIDS, HOUSEKEEPING AND UTILITY EQUIPMENT PADS, AND OTHER MAJOR ELEMENTS AS DIRECTED BY ARCHITECT AT THE BEGINNING OF THE PROJECT BEFORE PROCEEDING WITH CONSTRUCTION.
- 21. IN THE EVENT OF CONFLICT BETWEEN DATA SHOWN ON DRAWINGS AND DATA SHOWN IN THE SPECIFICATIONS, THE SPECIFICATIONS SHALLGOVERN DIMENSIONS NOTED ON DRAWINGS SHALL TAKE PRECEDENCE OVER SCALED DIMENSIONS. DETAIL DRAWINGS TAKE PRECEDENCE OVER DRAWINGS OF SMALLER SCALE. SHOULD THE CONTRACTOR AT ANY TIME DISCOVER AN ERROR IN A DRAWING OR SPECIFICATION, OR A DISCREPANCY OR VARIATION BETWEEN DIMENSIONS ON DRAWINGS AND MEASUREMENTS AT SITE, OR LACK OF DIMENSIONS OR OTHER INFORMATION, HE/SHE SHALL REPORT AT ONCE TO THE ARCHITECT FOR CLARIFICATION AND SHALL NOT PROCEED WITH THE WORK AFFECTED UNTIL CLARIFICATION HAS BEEN MADE.
- 22. OCCASIONAL REFERENCE TO ONE OR MORE SPECIFIC NOTES WITHIN GENERAL PLAN OR SHEET NOTES SHALL NOT IN ANY WAY DIMINISH OR ELIMINATE THE FULL FORCE AND EFFECT OF ALL OTHER NOTES, IN RELATION TO ONE ANOTHER OR NOT 23. THE CONTRACTOR SHALL CONTINUOUSLY CHECK ARCHITECTURAL AND STRUCTURAL CLEARANCES FOR ACCESSIBILITY OF EQUIPMENT AND ELECTRICAL SYSTEMS. CONTRACTOR SHALL VERIFY THAT NO CONFLICTS EXIST IN LOCATIONS OF
- ANY AND ALL MECHANICAL, TELEPHONE, ELECTRICAL, LIGHTING, PLUMBING AND SPRINKLER EQUIPMENT (TO INCLUDE ALL PIPING, DUCT WORK AND CONDUIT) AND THAT ALL REQUIRED CLEARANCES FOR INSTALLATION AND MAINTENANCE OF ABOVE EQUIPMENT ARE PROVIDED WHAT ELEMENTS ARE TO BE EXPOSED OR CONCEALED SHALL BE DETERMINED AND REVIEWED WITH ARCHITECT PRIOR TO PROCEEDING WITH CONSTRUCTION. NO ALLOWANCE OF ANY KIND WILL BE MADE FOR THE CONTRACTOR'S NEGLIGENCE TO NOTE OR FORESEE MEANS OF INSTALLING EQUIPMENT INTO POSITION INSIDE STRUCTURE. 24. WITH REFERENCE TO REFLECTED CEILINGS, CONTRACTORS SHALL COORDINATE WITH ALL TRADES INVOLVED AND PREPARE COMPOSITE SHOP DRAWINGS TO ENSURE LOCATIONS AND CLEARANCES FOR FIXTURES, DUCTS, CEILINGS, SPRINKLER HEADS,
- GRILLES ETC., NECESSARY TO MAINTAIN THE SPECIFIED FINISH CEILING HEIGHT ABOVE THE FINISH FLOOR AS NOTED ON THE DRAWINGS. CLARIFY CONFLICTS AND LOCATIONS WITH THE ARCHITECT BEFORE PROCEEDING. 25. WITHIN FIVE (5) DAYS FROM NOTICE TO PROCEED, PREPARE AND SUBMIT AN UPDATED PROGRESS SCHEDULE FOR THE WORK, WITH SUB-SCHEDULES OF RELATED ACTIVITIES WHICH MAY AFFECT THE PROGRESS.
- 26. MECHANICAL, ELECTRICAL, PLUMBING AND FIRE PROTECTION SYSTEMS, SHOP DRAWINGS AND LAYOUTS SHALL BE SUBMITTED AS SOON AS POSSIBLE AFTER AWARD OF CONTRACT TO THE ARCHITECT ALLOWING FIVE (5) WORKING DAYS FOR REVIEW. NO CONSTRUCTIONS SHALL PROCEED UNTIL THE APPROVAL OF THESE DRAWINGS. ALL THE ABOVE TRADES NEED TO BE REVIEWED BY THE ARCHITECT AT THE SAME TIME.
- 27. EXERCISE EXTREME CARE AND PRECAUTION DURING CONSTRUCTION OF THE WORK TO MINIMIZE DISTURBANCES TO ADJACENT STRUCTURES AND THEIR OCCUPANTS, PROPERTY, PUBLIC THOROUGHFARES, ETC. CONTRACTOR SHALL TAKE PRECAUTIONS AND BE RESPONSIBLE FOR THE SAFETY OF ALL BUILDING OCCUPANTS FROM CONSTRUCTION PROCEDURES.
- 28. CONTRACTOR SHALL WAIVE "COMMON PRACTICE" AND "COMMON USAGE" AS CONSTRUCTION CRITERIA WHEREVER DETAILS AND CONTRACT DOCUMENTS OR GOVERNING CODES, ORDINANCES, ETC. REQUIRE GREATER QUANTITY OR BETTER QUALITY THAN COMMON PRACTICE OR COMMON USE WOULD REQUIRE.
- 29. ONLY NEW ITEMS OF RECENT MANUFACTURE, OF STANDARD QUALITY, FREE FROM DEFECTS, WILL BE PERMITTED ON THE WORK. REJECTED ITEMS SHALL BE REMOVED IMMEDIATELY FROM THE WORK AND REPLACED WITH ITEMS OF THE QUALITY SPECIFIED. FAILURE TO REMOVE REJECTED MATERIALS AND EQUIPMENT SHALL NOT RELIEVE THE CONTRACTOR FROM THE RESPONSIBILITY FOR QUALITY AND CHARACTER OF ITEMS USED NOR FROM ANY OTHER OBLIGATION IMPOSED ON HIM BY THE CONTRACT. 30. MATERIALS AND WORKMANSHIP SPECIFIED BY REFERENCE TO NUMBER, SYMBOL TITLE OF A SPECIFICATION SUCH AS COMMERCIAL STANDARDS, FEDERAL SPECIFICATIONS, TRADE ASSOCIATION STANDARD, OR OTHER SIMILAR STANDARD, SHALL COMPLY WITH REQUIREMENTS IN LATEST EDITION OR REVISION THEREOF AND WITH ANY AMENDMENT OR SUPPLEMENT THERETOIN EFFECT ON DATE OF ORIGIN OF THIS PROJECT'S CONTRACT DOCUMENTS. SUCH STANDARD, EXCEPT AS MODIFIED HEREIN, SHALL HAVE FULL FORCE AND EFFECTS AS THOUGH PRINTED IN CONTRACT DOCUMENTS.
- 31. ARCHITECT, ACTING OWNER'S DESIGNATED AGENT FOR DESIGN OF THIS PROJECT, WILL EXERCISE AUTHORITY FOR DETERMINING CONFORMANCE OF MATERIALS, EQUIPMENT AND SYSTEMS WITH THE INTENT OF THE DESIGN. REVIEW AND ACCEPTANCE OF ALL ITEMS PROPOSED BY CONTRACTOR FOR INCORPORATION INTO THIS WORK WILL BE BY ARCHITECT. THIS FUNCTION OF THE ARCHITECT WILL APPLY BOTH TO THE CONTRACT AS INITIALLY SIGNED, AND TO CHANGES TO THE CONTRACT BY MODIFICATION
- 32. ABBREVIATIONS USED IN REFERRING TO STANDARDS THAT APPLY TO THE WORK INCLUDE, BUT ARE NOT NECESSARILY LIMITED TO, THE FOLLOWING:
 - A. AMERICAN SOCIETY FOR TESTING MATERIALS (ASTM) B. AMERICAN INSTITUTE OF STEEL CONSTRUCTION (AISC)
 - C. AMERICAN WELDING SOCIETY (AWS)
 - D. AMERICAN CONCRETE INSTITUTE (ACI) E. AMERICAN NATIONAL STANDARDS INSTITUTE (ANSI)
 - F. ARCHITECTURAL ALUMINUM MANUFACTURER'S ASSOCIATION (AAMA) G. ALUMINUM ASSOCIATION, INC. (AA)
 - H. CONCRETE REINFORCING STEEL INSTITUTE (CRSI)
 - I. NATIONAL ASSOCIATION OF ARCHITECTURAL METAL MANUFACTURERS (NAAMM) J. NATIONAL FIRE PROTECTION ASSOCIATION (NFPA)
 - K. NATIONAL WOODWORK MANUFACTURER'S ASSOCIATION (NWMA)
- L. WOODWORK INSTITUTE OF CALIFORNIA (WIC) 33. CONTRACTOR SHALL ORDER AND SCHEDULE DELIVERY OF MATERIALS IN AMPLE TIME TO AVOID DELAYS IN CONSTRUCTION. IF AN ITEM IS FOUND TO BE UNAVAILABLE, CONTRACTOR SHALL NOTIFY ARCHITECT IMMEDIATELY TO ALLOW ARCHITECT A
- REASONABLE AMOUNT OF TIME TO SELECT A REASONABLE SUBSTITUTE. 34. SUBSTITUTION REQUEST WILL BE CONSIDERED DURING THE PRICING PERIOD AND THEREAFTER ONLY WHEN A PRODUCT BECOMES UNAVAILABLE. ALL REQUESTS FOR SUBSTITUTIONS OF ITEMS SPECIFIED SHALL BE SUBMITTED IN WRITING AND WILL BE CONSIDERED ONLY IF BETTER SERVICE FACILITIES, A MORE ADVANTAGEOUS DELIVERY DATE OR A LOWER PRICE WITH CREDIT TO THE TENANT WILL BE PROVIDED WITHOUT SACRIFICING QUALITY, APPEARANCE AND FUNCTION. UNDER NO CIRCUMSTANCES WILL THE ARCHITECT BE REQUIRED TO PROVE THAT A PRODUCT PROPOSED FOR SUBSTITUTION IS OR IS NOT OF EQUAL QUALITY TO THE PRODUCT SPECIFIED.
- 35. MINIMUM INSULATION VALUES SHALL BE AS PER BASE BUILDING REQUIREMENTS. 36. ALL GLASS AND GLAZING USED IN THIS PROJECT SHALL CONFORM TO REQUIREMENTS OF THE 2016 CALIFORNIA BUILDING CODE.
- 37. ALL DOOR AND SIDELIGHT GLAZING, BATH AND SHOWER ENCLOSURE GLAZING, GLAZING WITHIN 18" OF WALKING SURFACES, AND OTHER GLAZING IN 'HAZARDOUS LOCATIONS' SHALL BE TEMPERED OR LAMINATED SAFETY GLASS.
- 38. UNDERCUT DOORS TO CLEAR TOP OF FLOOR FINISHES BY 1/4" U.O.N.
- 39. COORDINATE AND PROVIDE APPROPRIATE STRUCTURAL BLOCKING /BACKING AND REINFORCING IN PARTITIONS BEHIND ALL WALL-MOUNTED ITEMS. 40. MAKE ALL NECESSARY PROVISIONS FOR ITEMS TO BE FURNISHED OR INSTALLED BY TENANT. PROVIDE PROTECTION FOR THESE PROVISIONS UNTIL COMPLETION OF THE PROJECT. GENERAL CONTRACTOR TO COORDINATE ALL N.I.C. ITEMS WITH
- 41. ATTACHMENTS, CONNECTIONS, OR FASTENINGS OF ANY NATURE ARE TO BE PROPERLY AND PERMANENTLY SECURED IN CONFORMANCE WITH BEST PRACTICE. THE CONTRACTOR IS RESPONSIBLE FOR IMPROVING THEM ACCORDING TO THESE CONDITIONS.
- THE DRAWINGS SHOW ONLY SPECIAL CONDITIONS TO ASSIST THE CONTRACTOR; THEY DO NOT ILLUSTRATE EVERY SUCH CONDITION AND DETAIL. 42. PATCH AND REPAIR ALL FIREPROOFING DAMAGED OR REMOVED DURING PERFORMANCE OF THE WORK. FIREPROOF NEW PENETRATIONS REQUIRED BY THE WORK.
- 41. MAINTAIN EXITS, EXIT LIGHTING, FIRE PROTECTIVE DEVICES AND ALARMS IN CONFORMANCE WITH CODES AND ORDINANCES. 42. ALL TELEPHONE AND DATA WORK SHALL BE COORDINATED BY THE CONTRACTOR WITH TENANT OR TENANT'S REPRESENTATIVE.
- 43. IF AT ANY TIME BEFORE COMMENCEMENT OF WORK, OR DURING PROCESS THEREOF, CONTRACTOR'S METHODS, EQUIPMENT OR APPLIANCES ARE INEFFICIENT OR INAPPROPRIATE FOR SECURING QUALITY OF WORK, OR RATE OF PROGRESS INTENDED BY CONTRACT DOCUMENTS, OWNER MAY ORDER CONTRACTOR TO IMPROVE THEIR QUALITY OR INCREASE THEIR EFFICIENCY. THIS WILL NOT RELIEVE CONTRACTOR OF HIS SURETIES FROM THEIR OBLIGATIONS TO SECURE QUALITY OF WORK AND RATE OF
- PROGRESS SPECIFIED IN CONTRACT. 44. THE FINISHED WORK SHALL BE FIRM, WELL-ANCHORED, IN TRUE ALIGNMENT, PLUMB, LEVEL WITH SMOOTH, CLEAN, UNIFORM APPEARANCE WITHOUT WAVES, DISTORTIONS, HOLES, MARKS, CRACKS, STAINS OR DISCOLORATION. JOINTINGS SHALL BE TIGHT FITTING, NEAT AND WELL SCRIBED. THE FINISHED WORK SHALL NOT HAVE EXPOSED UNSIGHTLY ANCHORS OR FASTENERS AND SHALL NOT PRESENT HAZARDOUS, UNSAFE CORNERS. ALL WORK SHALL HAVE THE PROVISION FOR EXPANSION, CONTRACTION AND
- SHRINKAGE AS NECESSARY TO PREVENT CRACKS, BUCKLING AND WARPING DUE TO TEMPERATURE AND HUMIDITY CONDITIONS. 45. NO WORK DEFECTIVE IN CONSTRUCTION OR QUALITY OR DEFICIENT IN ANY REQUIREMENTS OF DRAWINGS AND SPECIFICATIONS WILL BE ACCEPTABLE IN CONSEQUENCE OF OWNER'S OR ARCHITECT'S FAILURE TO DISCOVER OR TO POINT OUT DEFECTS OR DEFICIENCIES DURING CONSTRUCTION; NOR WILL PRESENCE OF INSPECTORS ON WORK SITE RELIEVE CONTRACTOR FROM RESPONSIBILITY FOR SECURING QUALITY AND PROGRESS OF WORK AS REQUIRED BY CONTRACT. DEFECTIVE WORK REVEALED WITHIN TIME REQUIRED BY GUARANTEES SHALL BE REPLACED BY WORK CONFORMING WITH INTENT OF CONTRACT, NO PAYMENT WHETHER PARTIAL OR FINAL SHALL BE CONSTRUED AS AN ACCEPTANCE OF DEFECTIVE WORK OR IMPROPER MATERIALS.
- 46. CONTRACTOR SHALL BE RESPONSIBLE FOR THE GENERAL CLEANING OF A JOB AFTER ITS COMPLETION. CLEANING SHALL INCLUDE INTERIOR OF THE BUILDING AND PATH OF TRAVEL TO THE JOB SITE AND SHALL INCLUDE THE PARKING LOT, ELEVATORS. LOBBIES AND CORRIDOR CARPET.
- 47. PUBLIC RESTROOMS SHALL NOT BE USED TO CLEAN EQUIPMENT.
- 48. CONTRACTOR SHALL PROVIDE RECORD DOCUMENTS AND SHALL PROVIDE SAID DOCUMENTATION TO CONSTRUCTION MANAGER UPON UPON COMPLETION OF TENANT CONSTRUCTION. NO EXCEPTIONS

VICINITY MAP



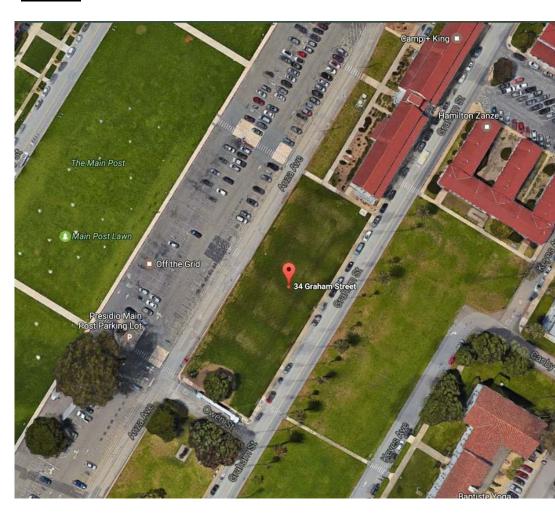

PROJECT DIRECTORY

NATIONAL GEOGRAPHIC NATIONAL GEOGRAPHIC 1145 17TH STREET N.W. ADDRESS: WASHINGTON, D.C. 20036-4688 EDUCATION@NGS.ORG

BOBBIE LEE HUGHES

563-321-0547

DESIGNER/DRAFTER: PHONE: EMAIL: BHUGHES.DESIGNS@GMAIL.COM

CONTRACTOR CONTRACTOR: **BUISNESS:** BUISNESS: ADDRESS: ADDRESS: EMAIL: PHONE: PHONE:

PROJECT/SITE DATA


ADDRESS: 34 GRAHAM STREET SAN FRANCISCO, CA 94129 YEAR BUILT: YEAR BUILT: **BUILDING AREA: BUILDING AREA:** PARCEL AREA: PARCEL AREA: PROJECT GROSS AREA: PROJECT GROSS AREA: PROJECT NET AREA: PROJECT NET AREA: NEIGHBORHOOD:

SCOPE OF PROJECT: FULL DESIGN OF INTERIOR AND EXISTING PLAN ON LEVELS ONE AND TWO.

SHEET INDEX


A0.0	COVER SHEET
A1.0	SITE PLAN
A2.0	LEVEL ONE FLOOR PLAN
A2.1	LEVEL TWO FLOOR PLAN
A2.2	LEVEL ONE FF&E
A2.3	LEVEL TWO FF&E
A2.4	LEVEL ONE EXIT PLAN
A2.5	LEVEL TWO EXIT PLAN
A2.6	LEVEL TWO POWER/SIGNAL PLAN
A3.0	LEVEL ONE RCP
A3.1	LEVEL TWO RCP
A3.2	CONF. RM. RCP
A5.0	LEVEL ONE INTERIOR ELEVATIONS
A5.1	LEVEL ONE INTERIOR ELEVATIONS
A5.2	LEVEL ONE INTERIOR ELEVATIONS
A5.3	LEVEL TWO INTERIOR ELEVATIONS
A5.4	LEVEL TWO INTERIOR ELEVATIONS
A5.5	LEVEL TWO INTERIOR ELEVATIONS
A6.0	SECTIONS
A7.0	LEVEL ONE DETAILS
A7.1	LEVEL TWO DETAILS
A8.0	EXTERIOR ELEVATIONS

SYMBOL LEGEND

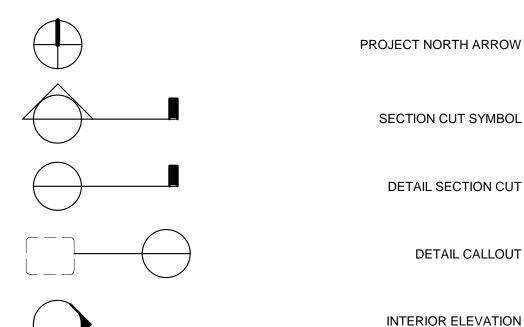



LEVEL SYMBOL

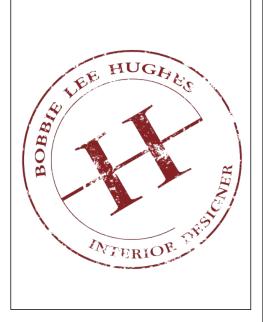

(J)

NATIONAL **GEOGRAPHIC**

00004 Project number MAY 25, 2017 Drawn by Checked by

SITE MAP

Project number MAY 25, 2017

A1.0

1/16" = 1'-0"


ANZA AVENUE


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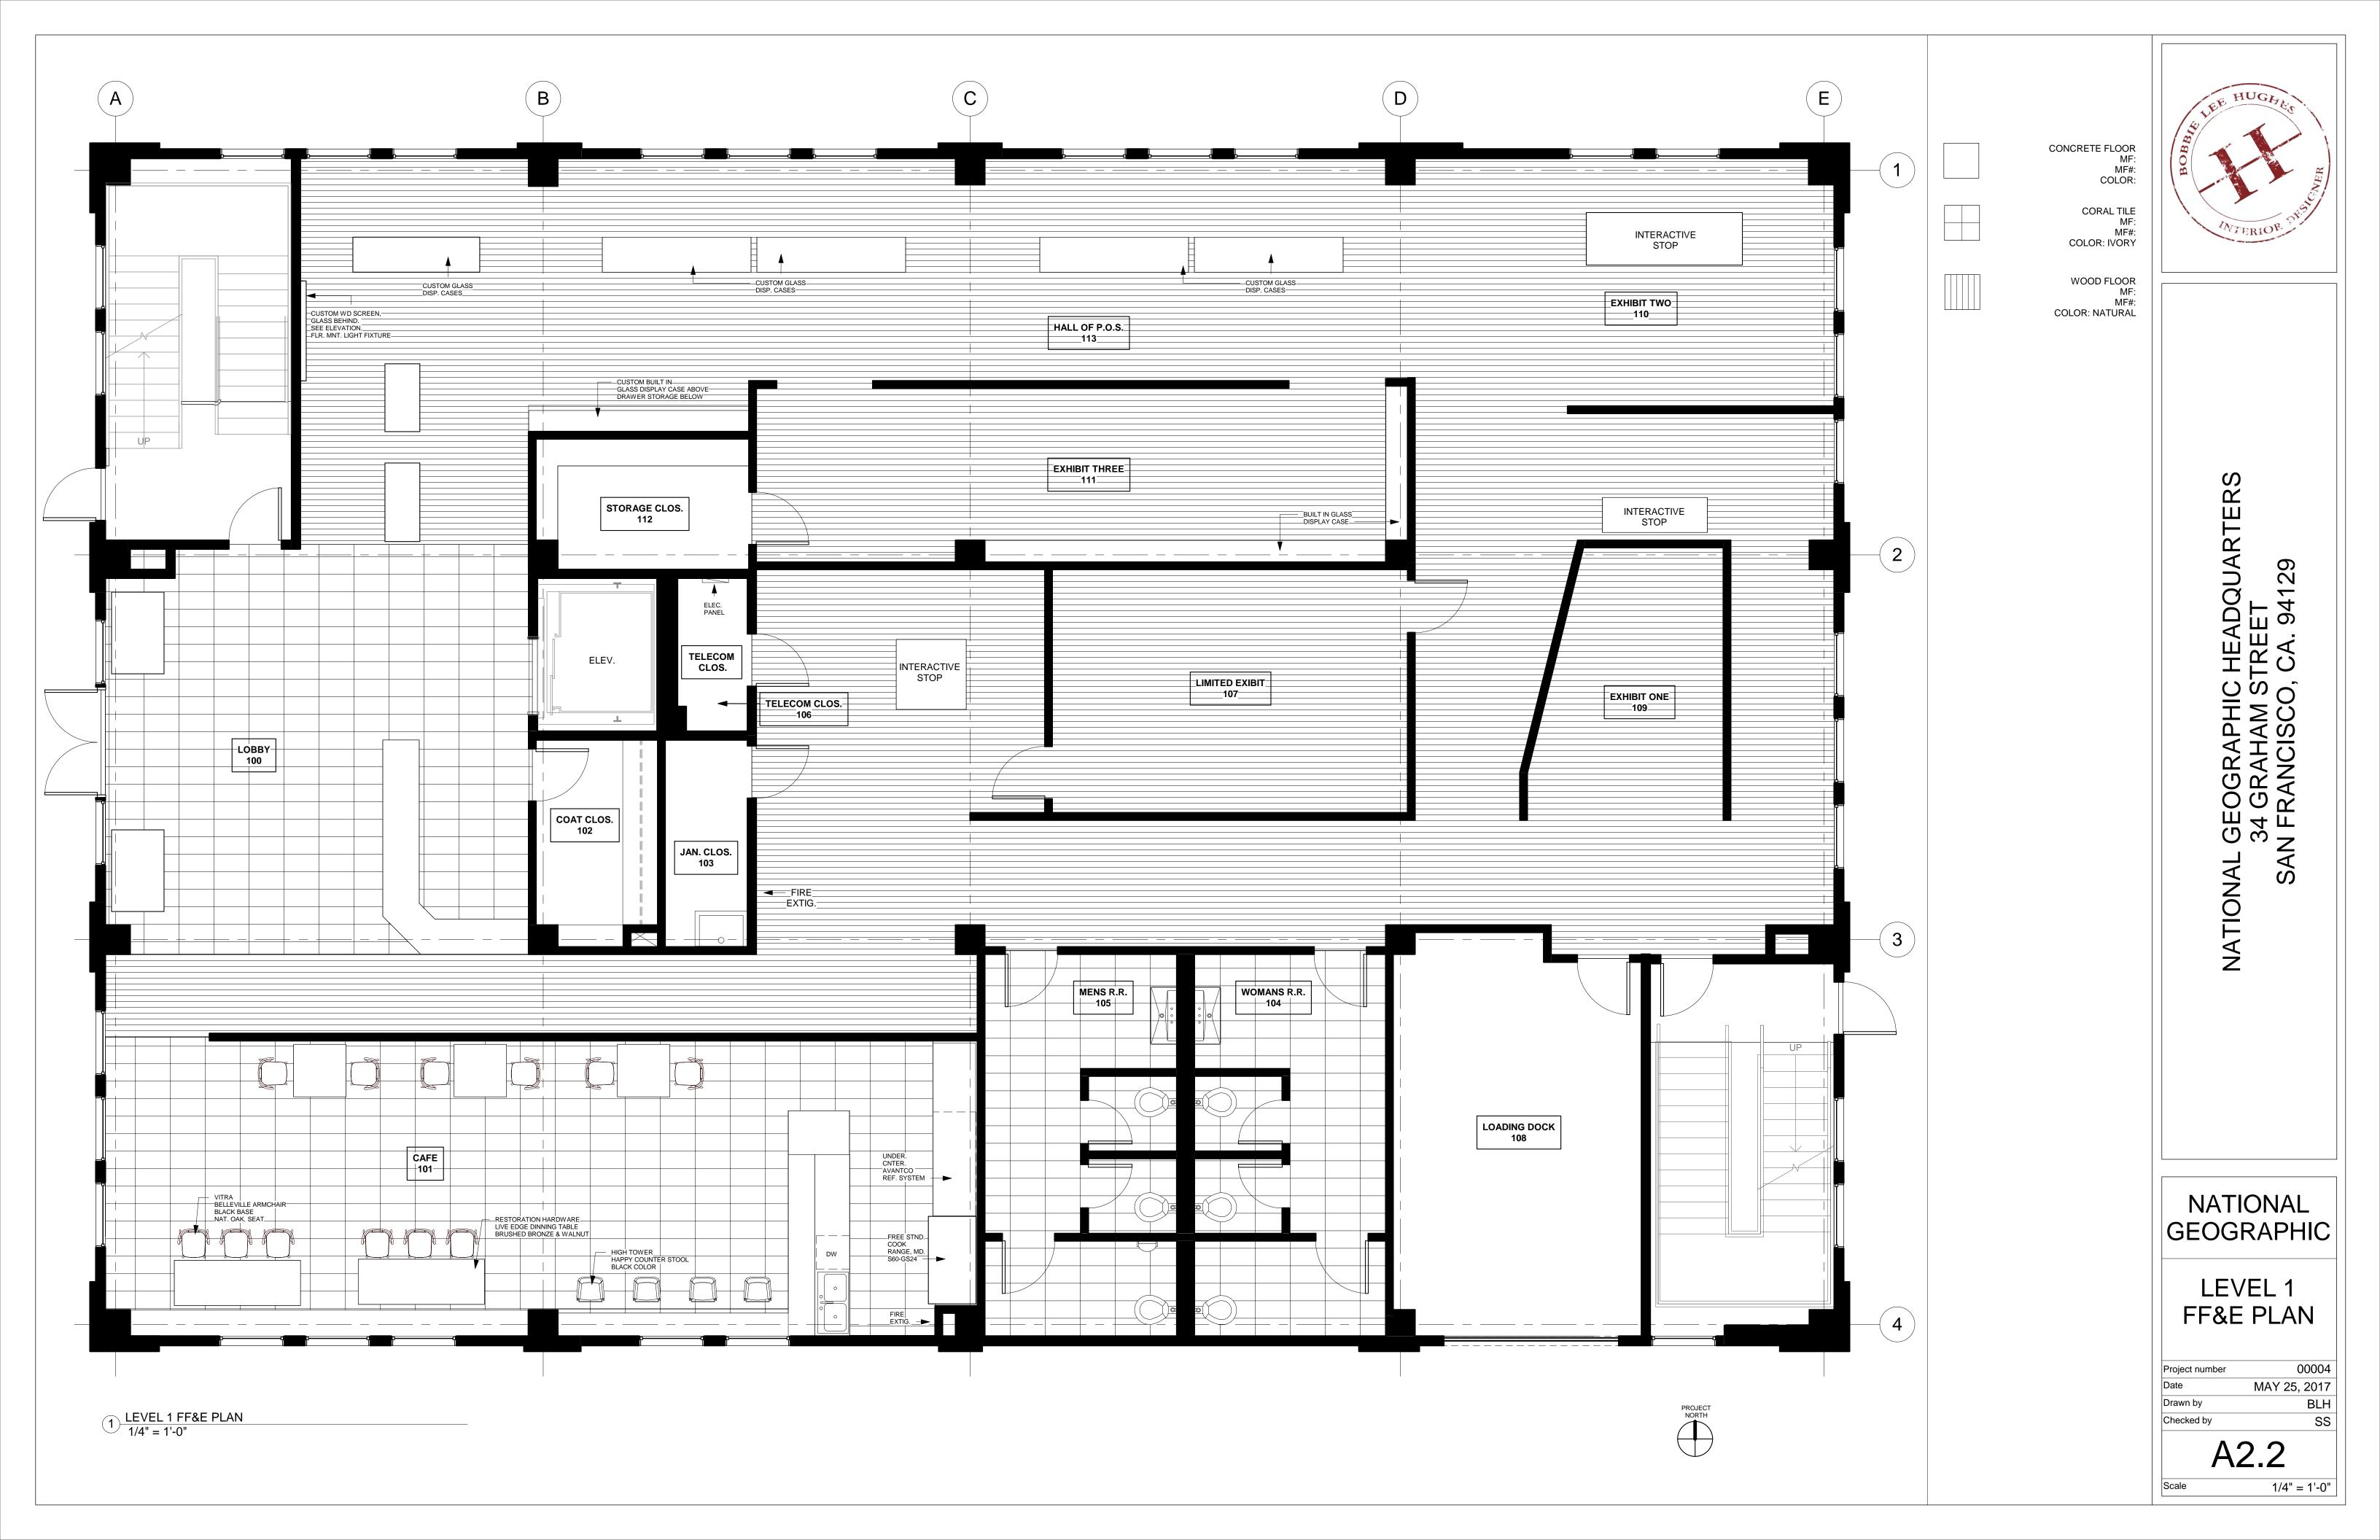
GRAHAM STREET


1 SITE PLAN 1/16" = 1'-0"






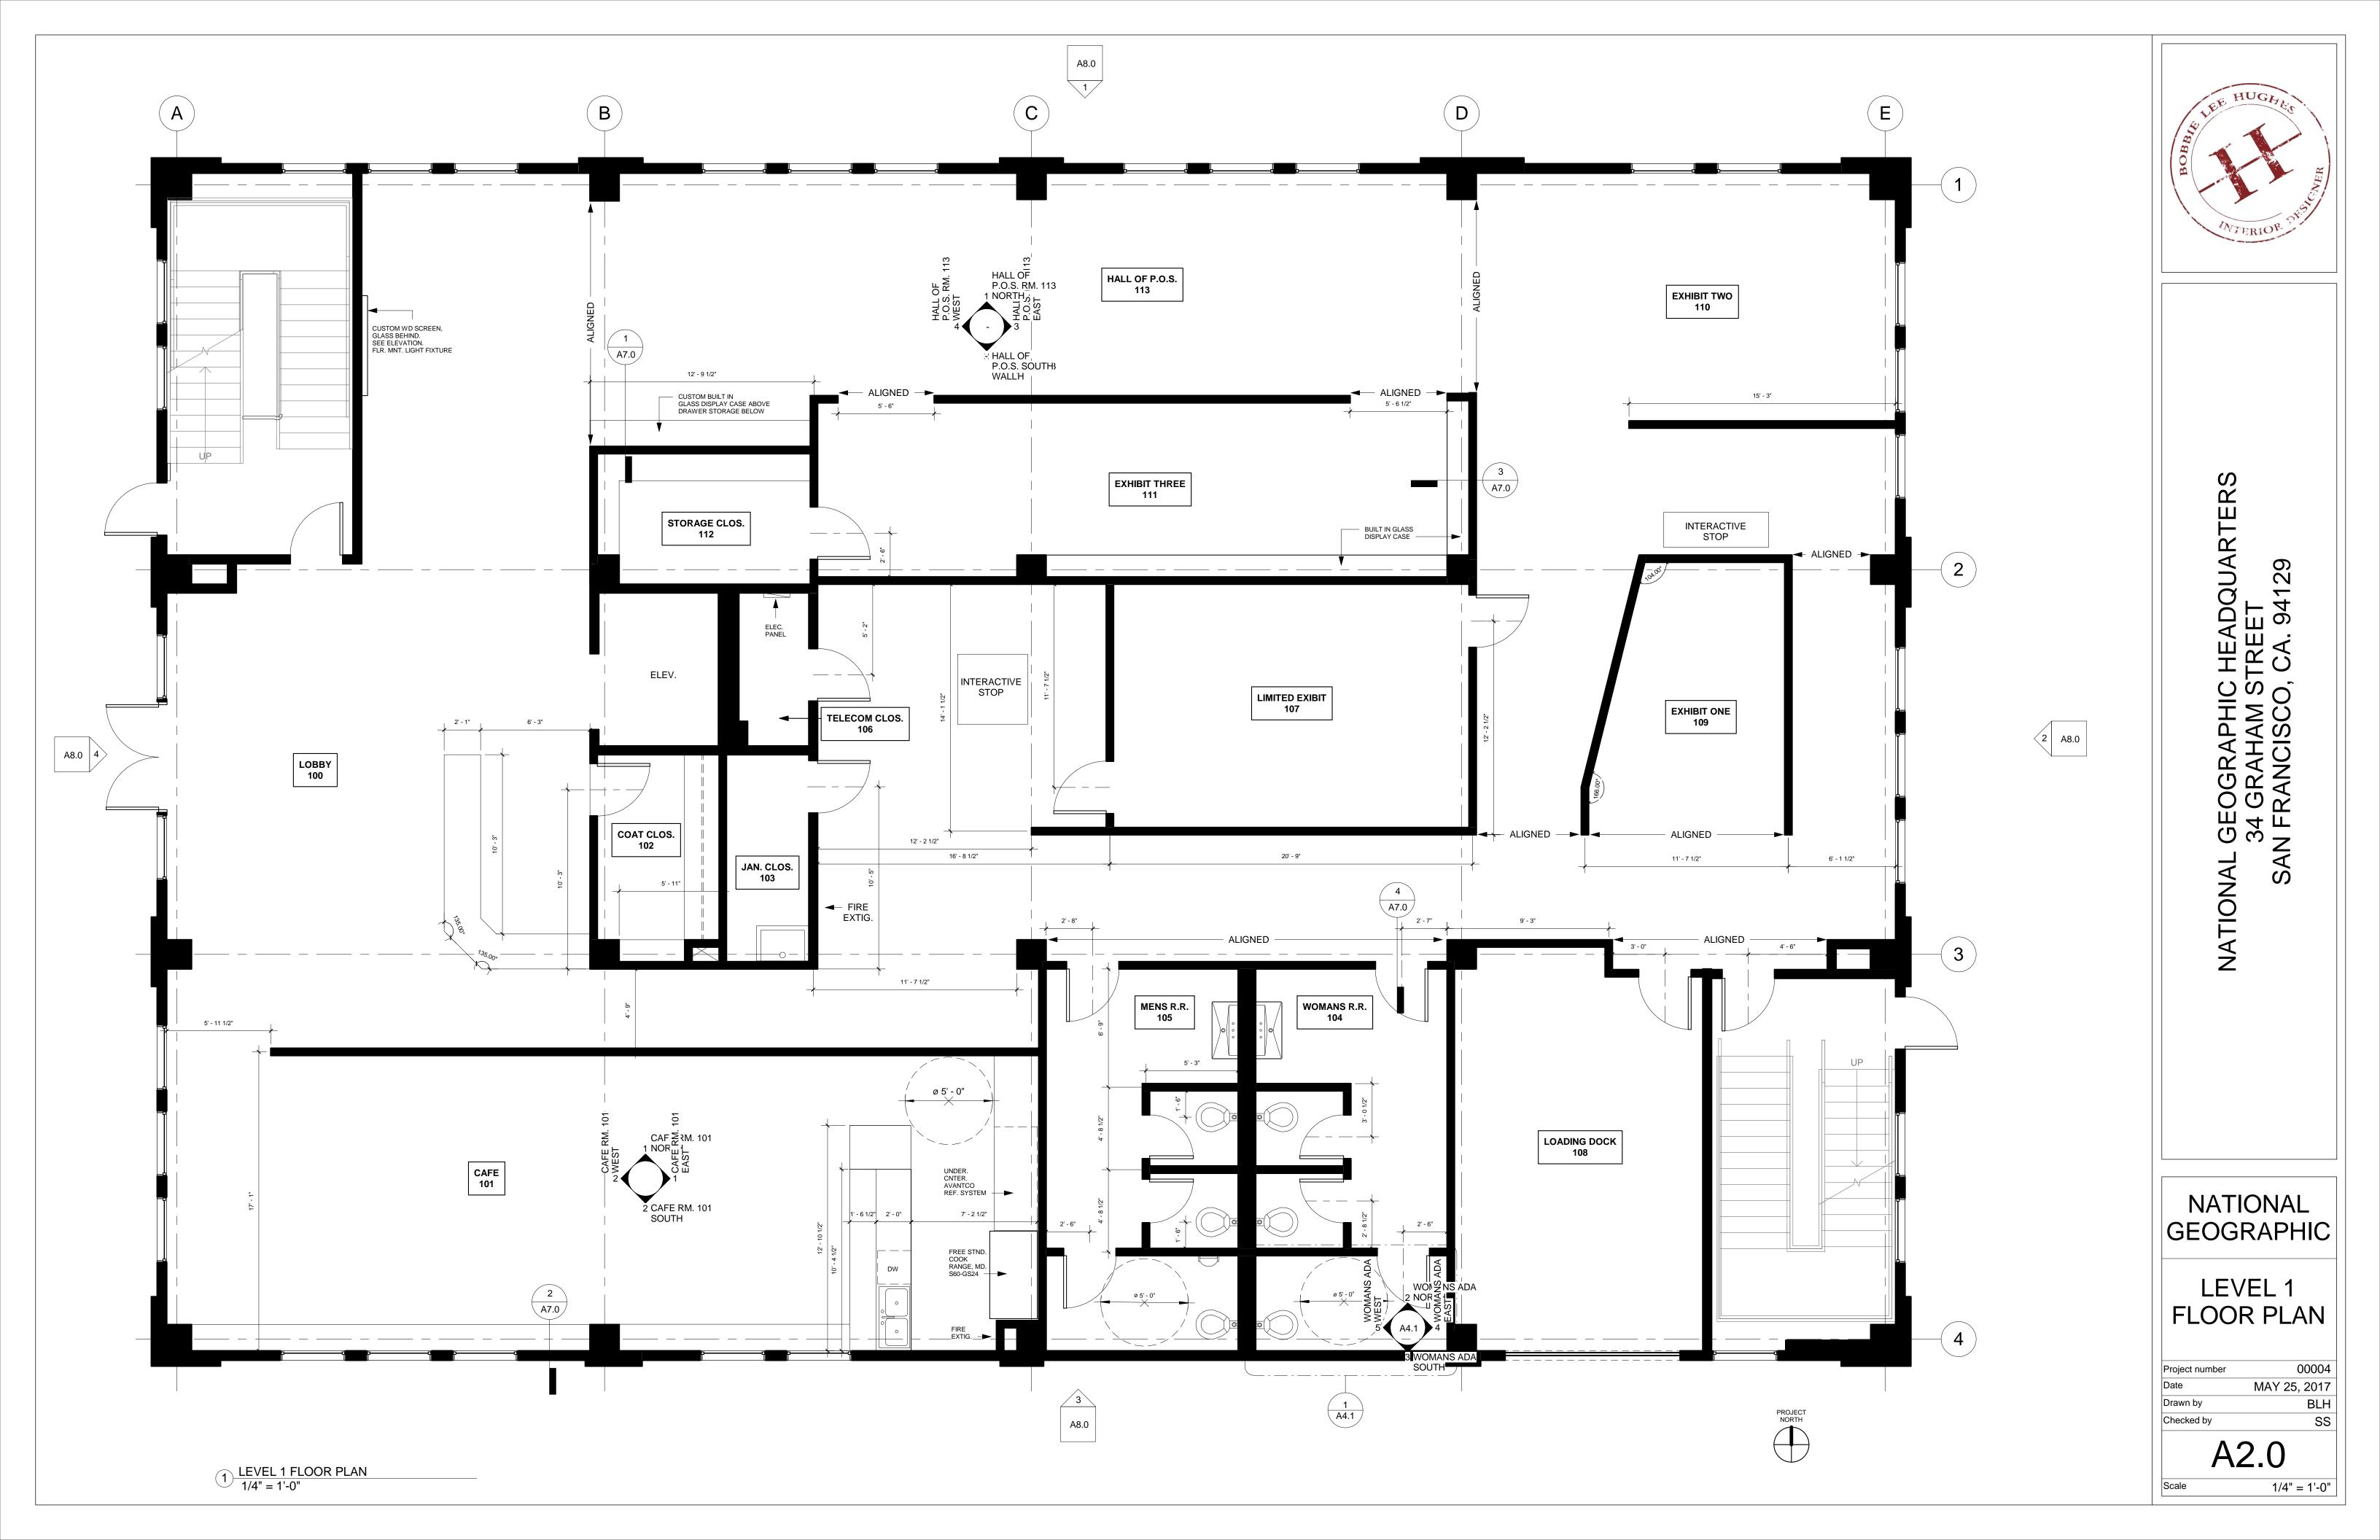

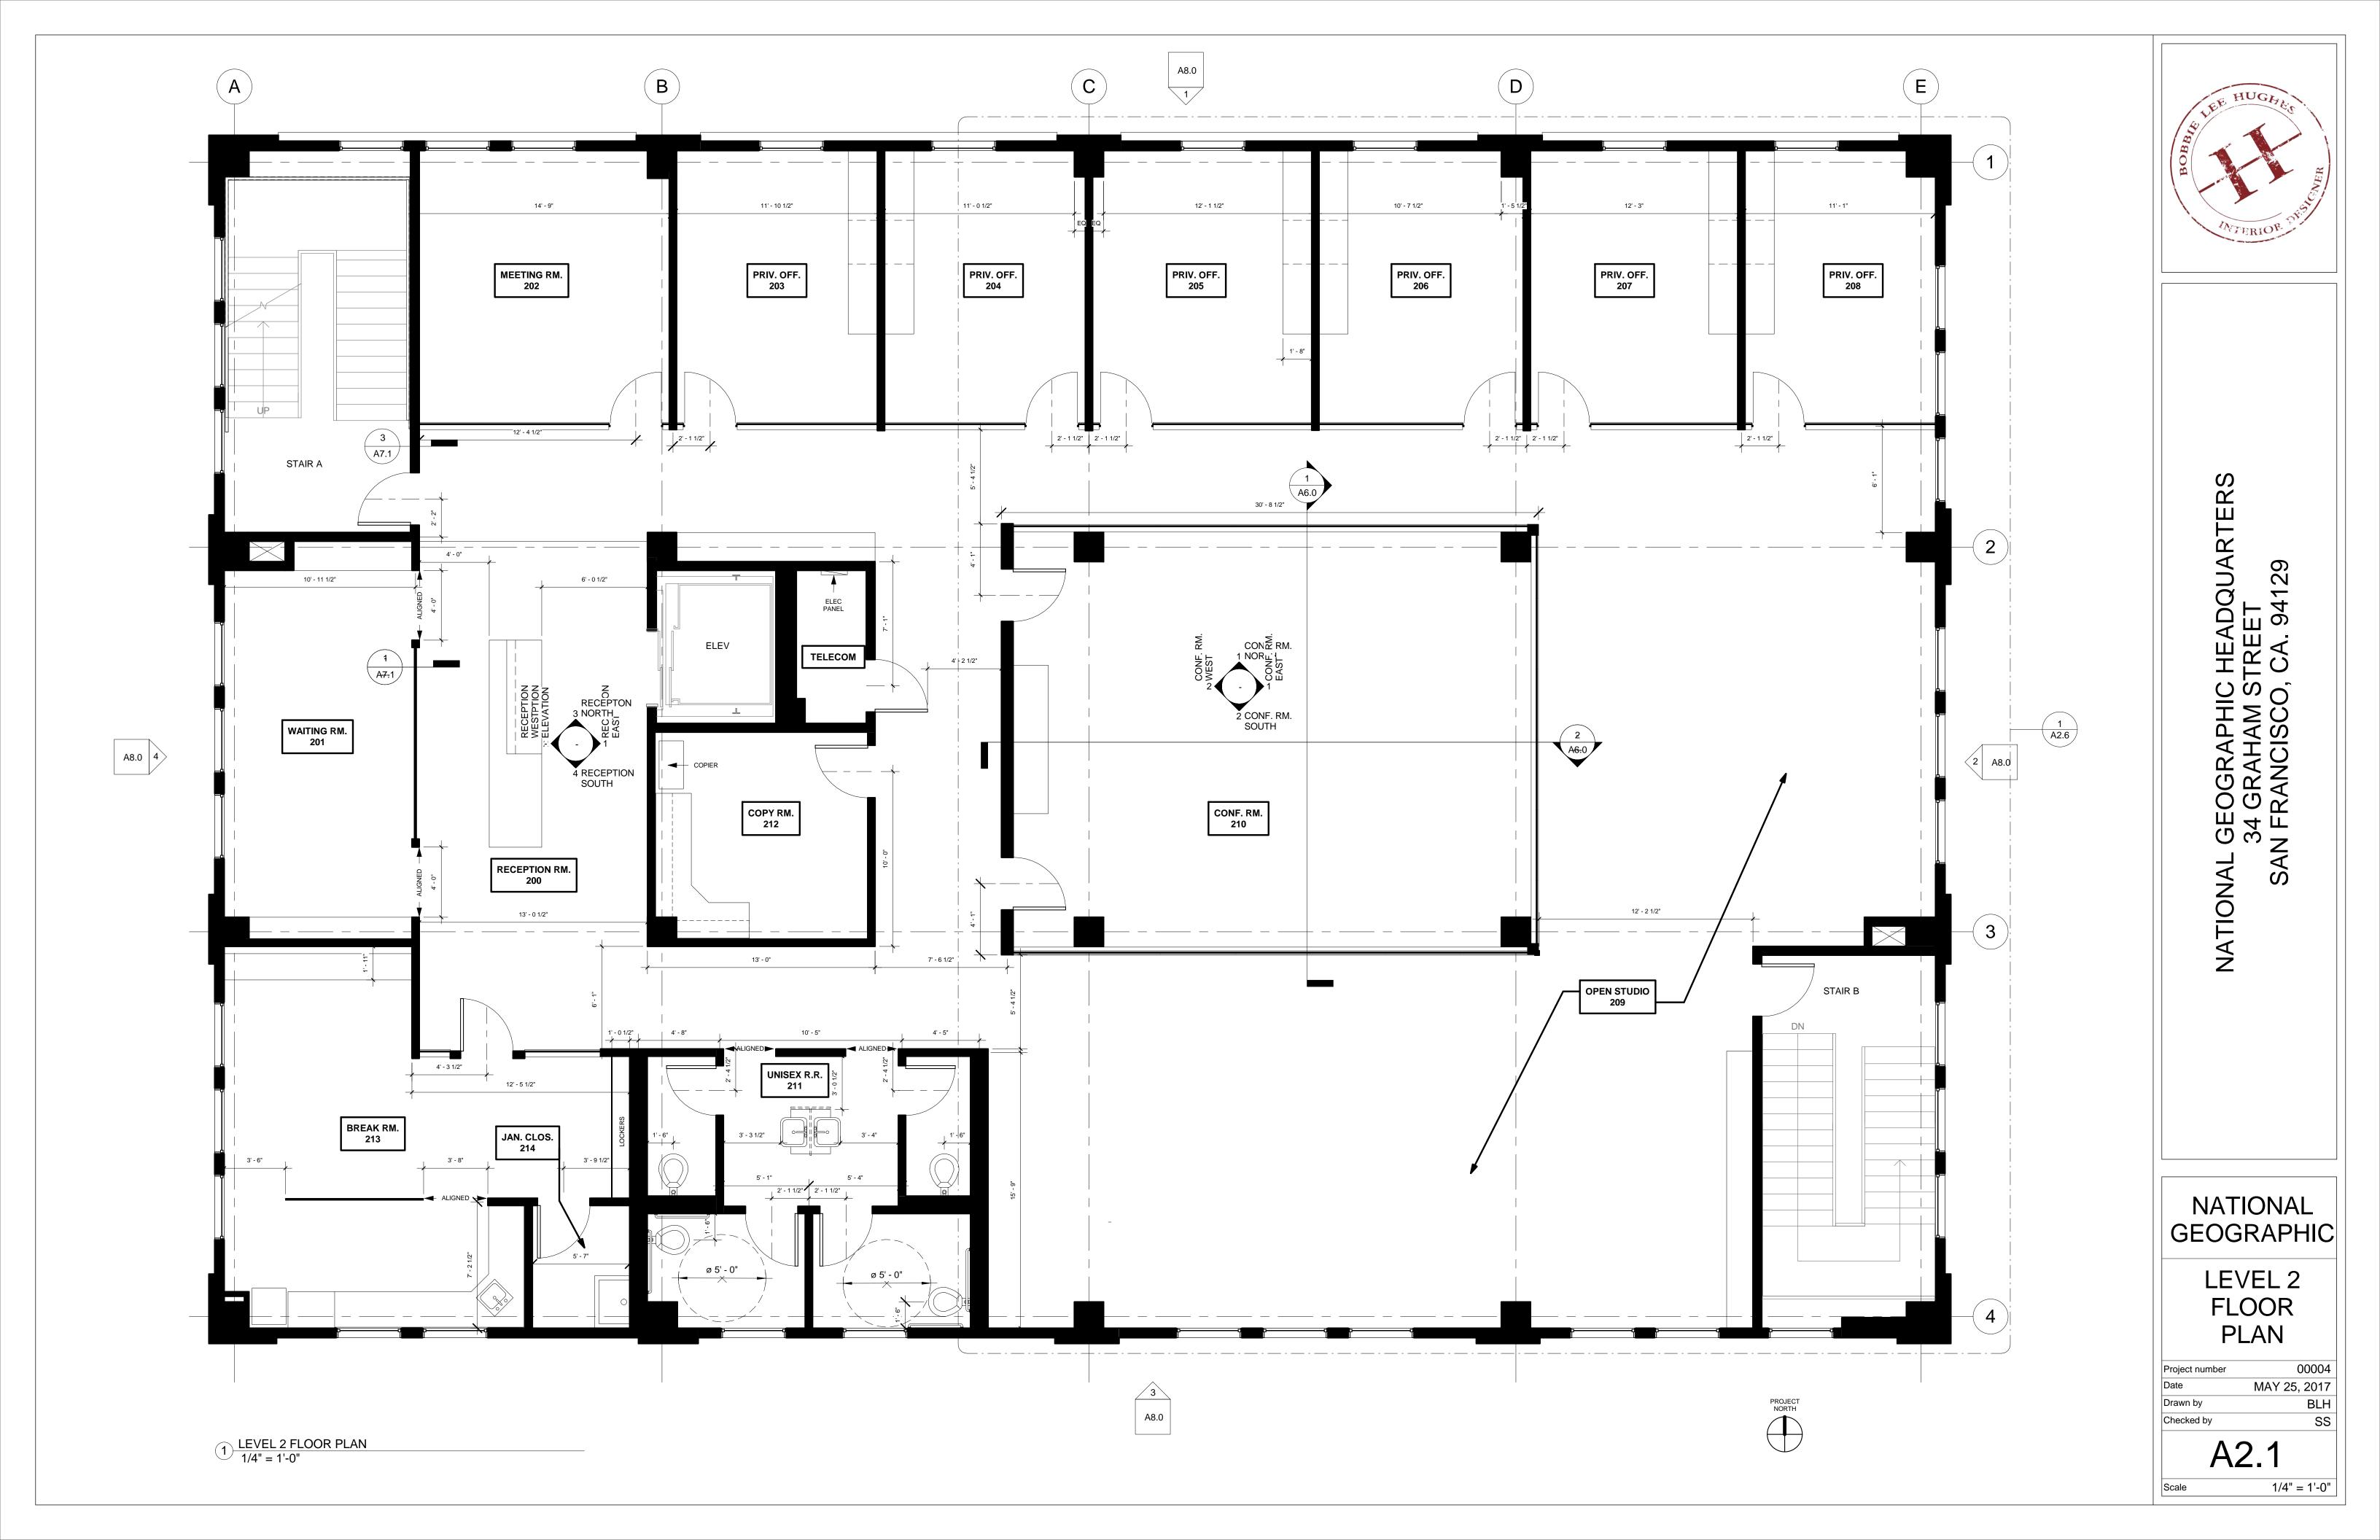

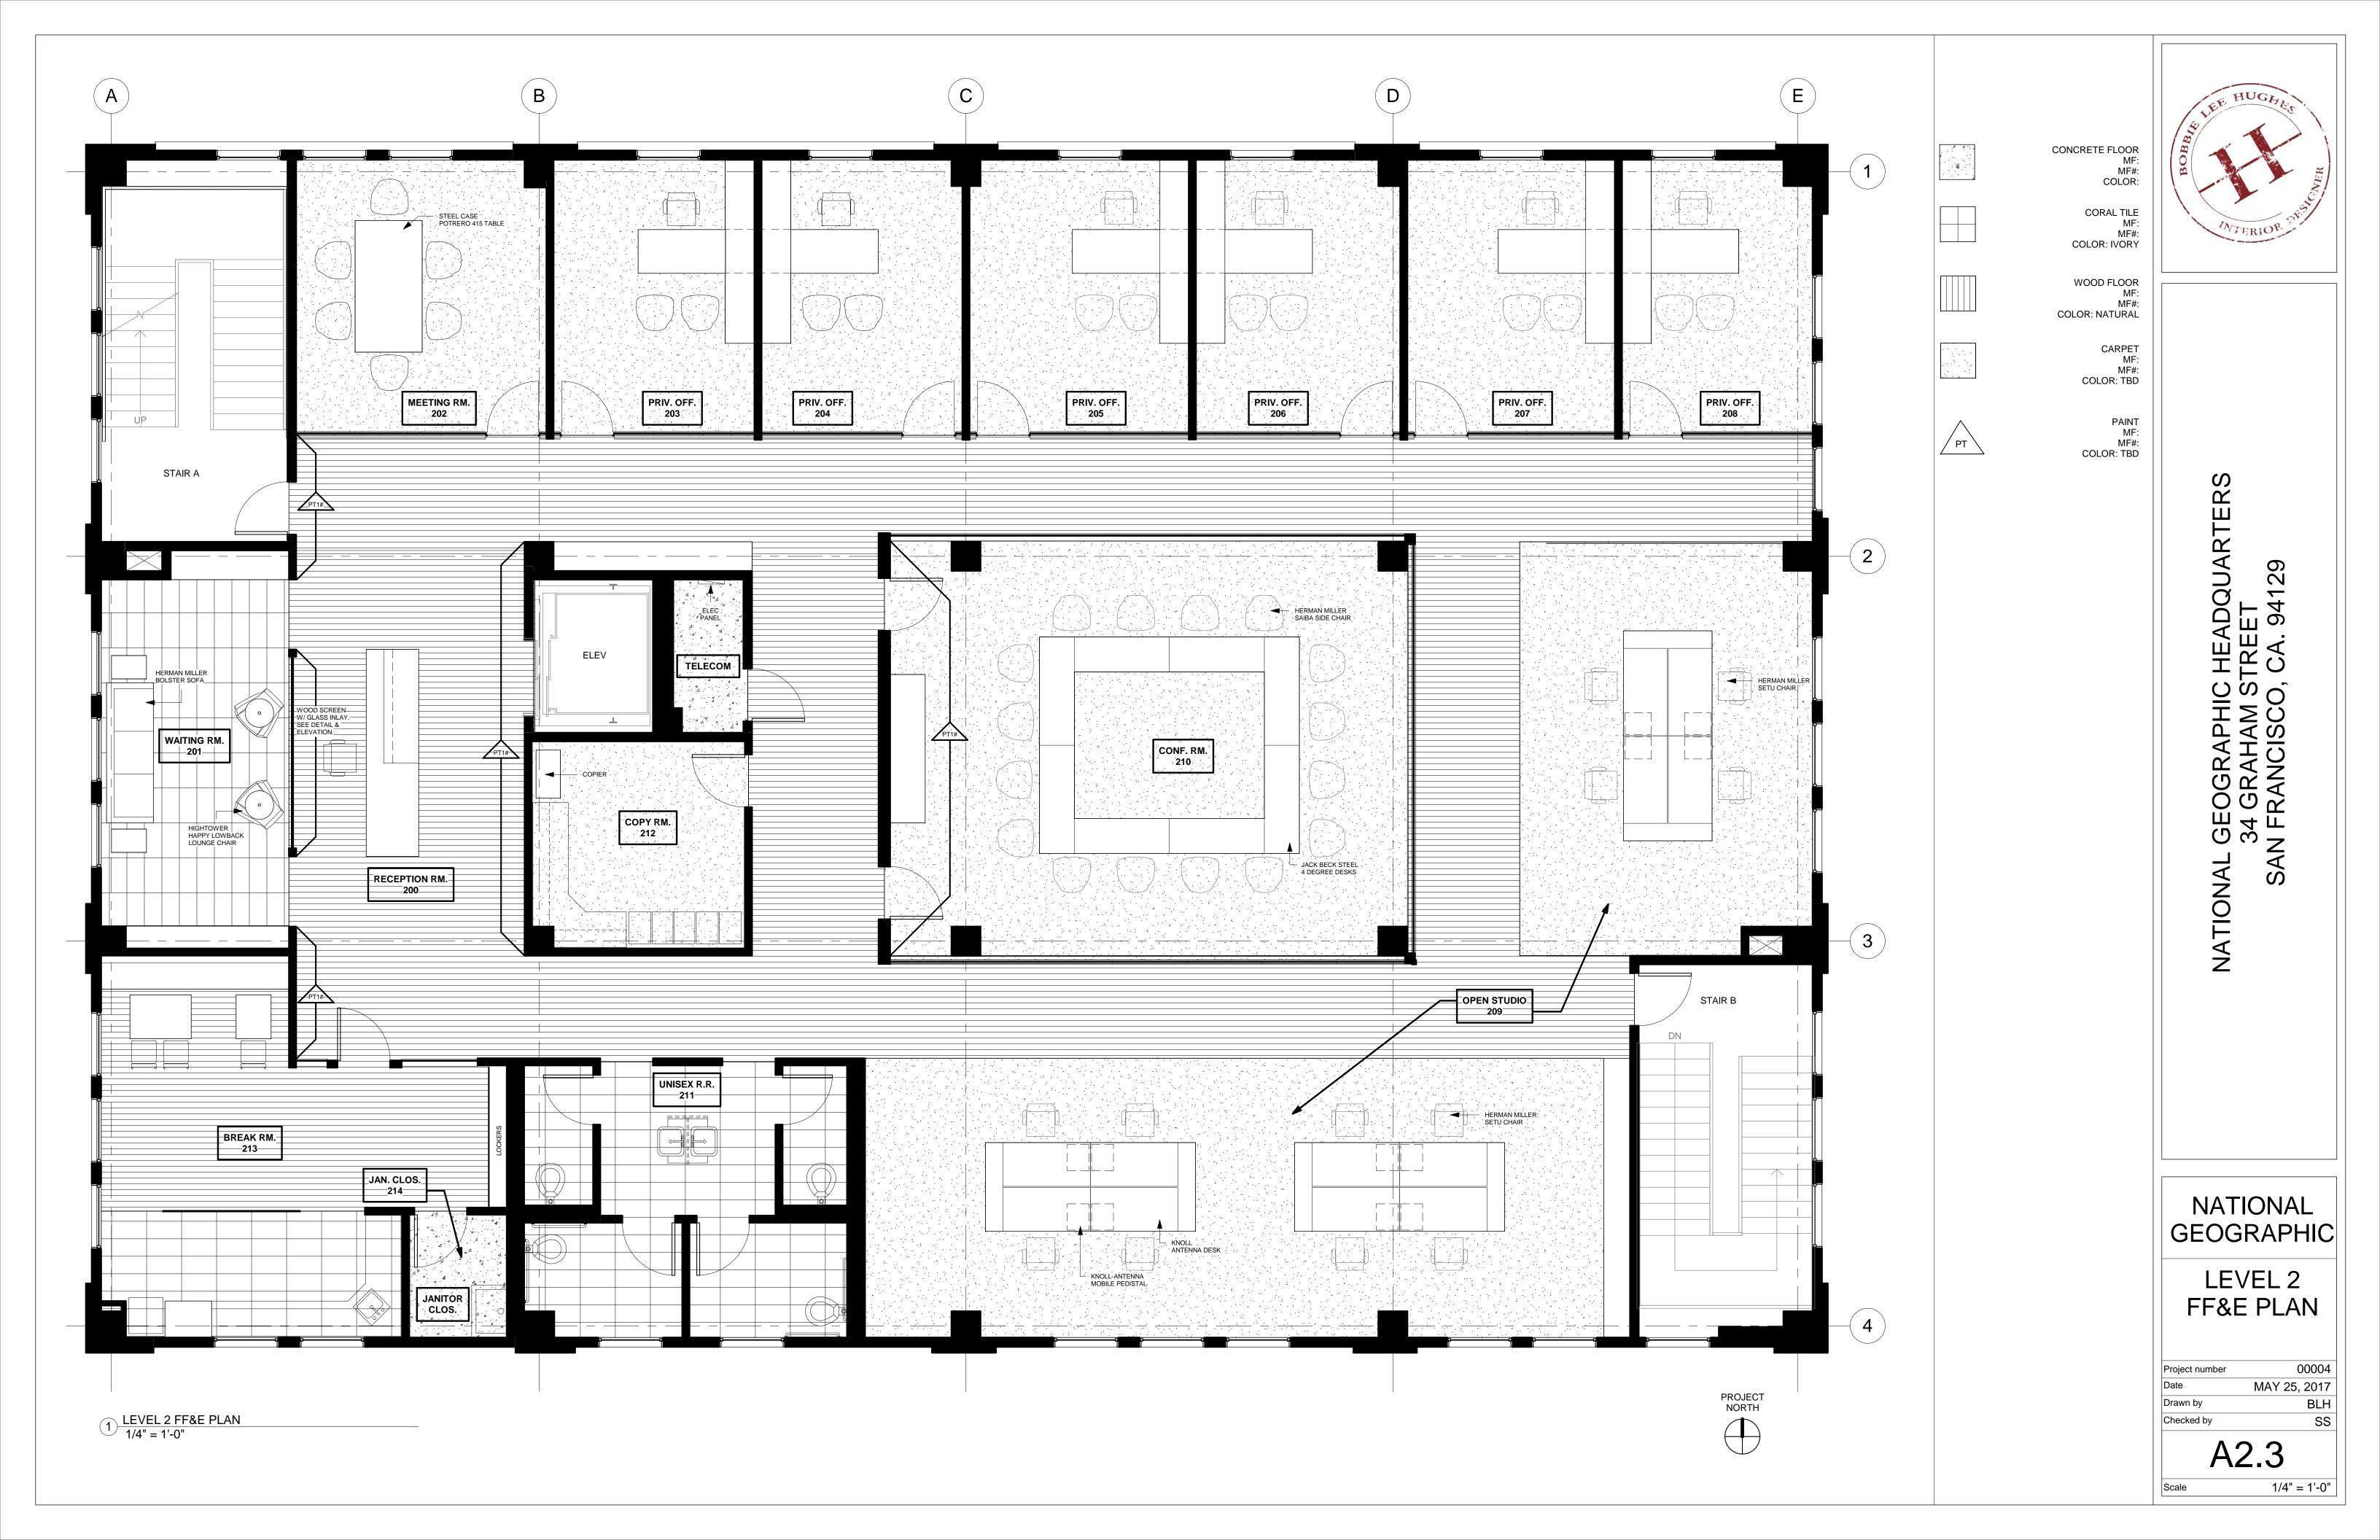

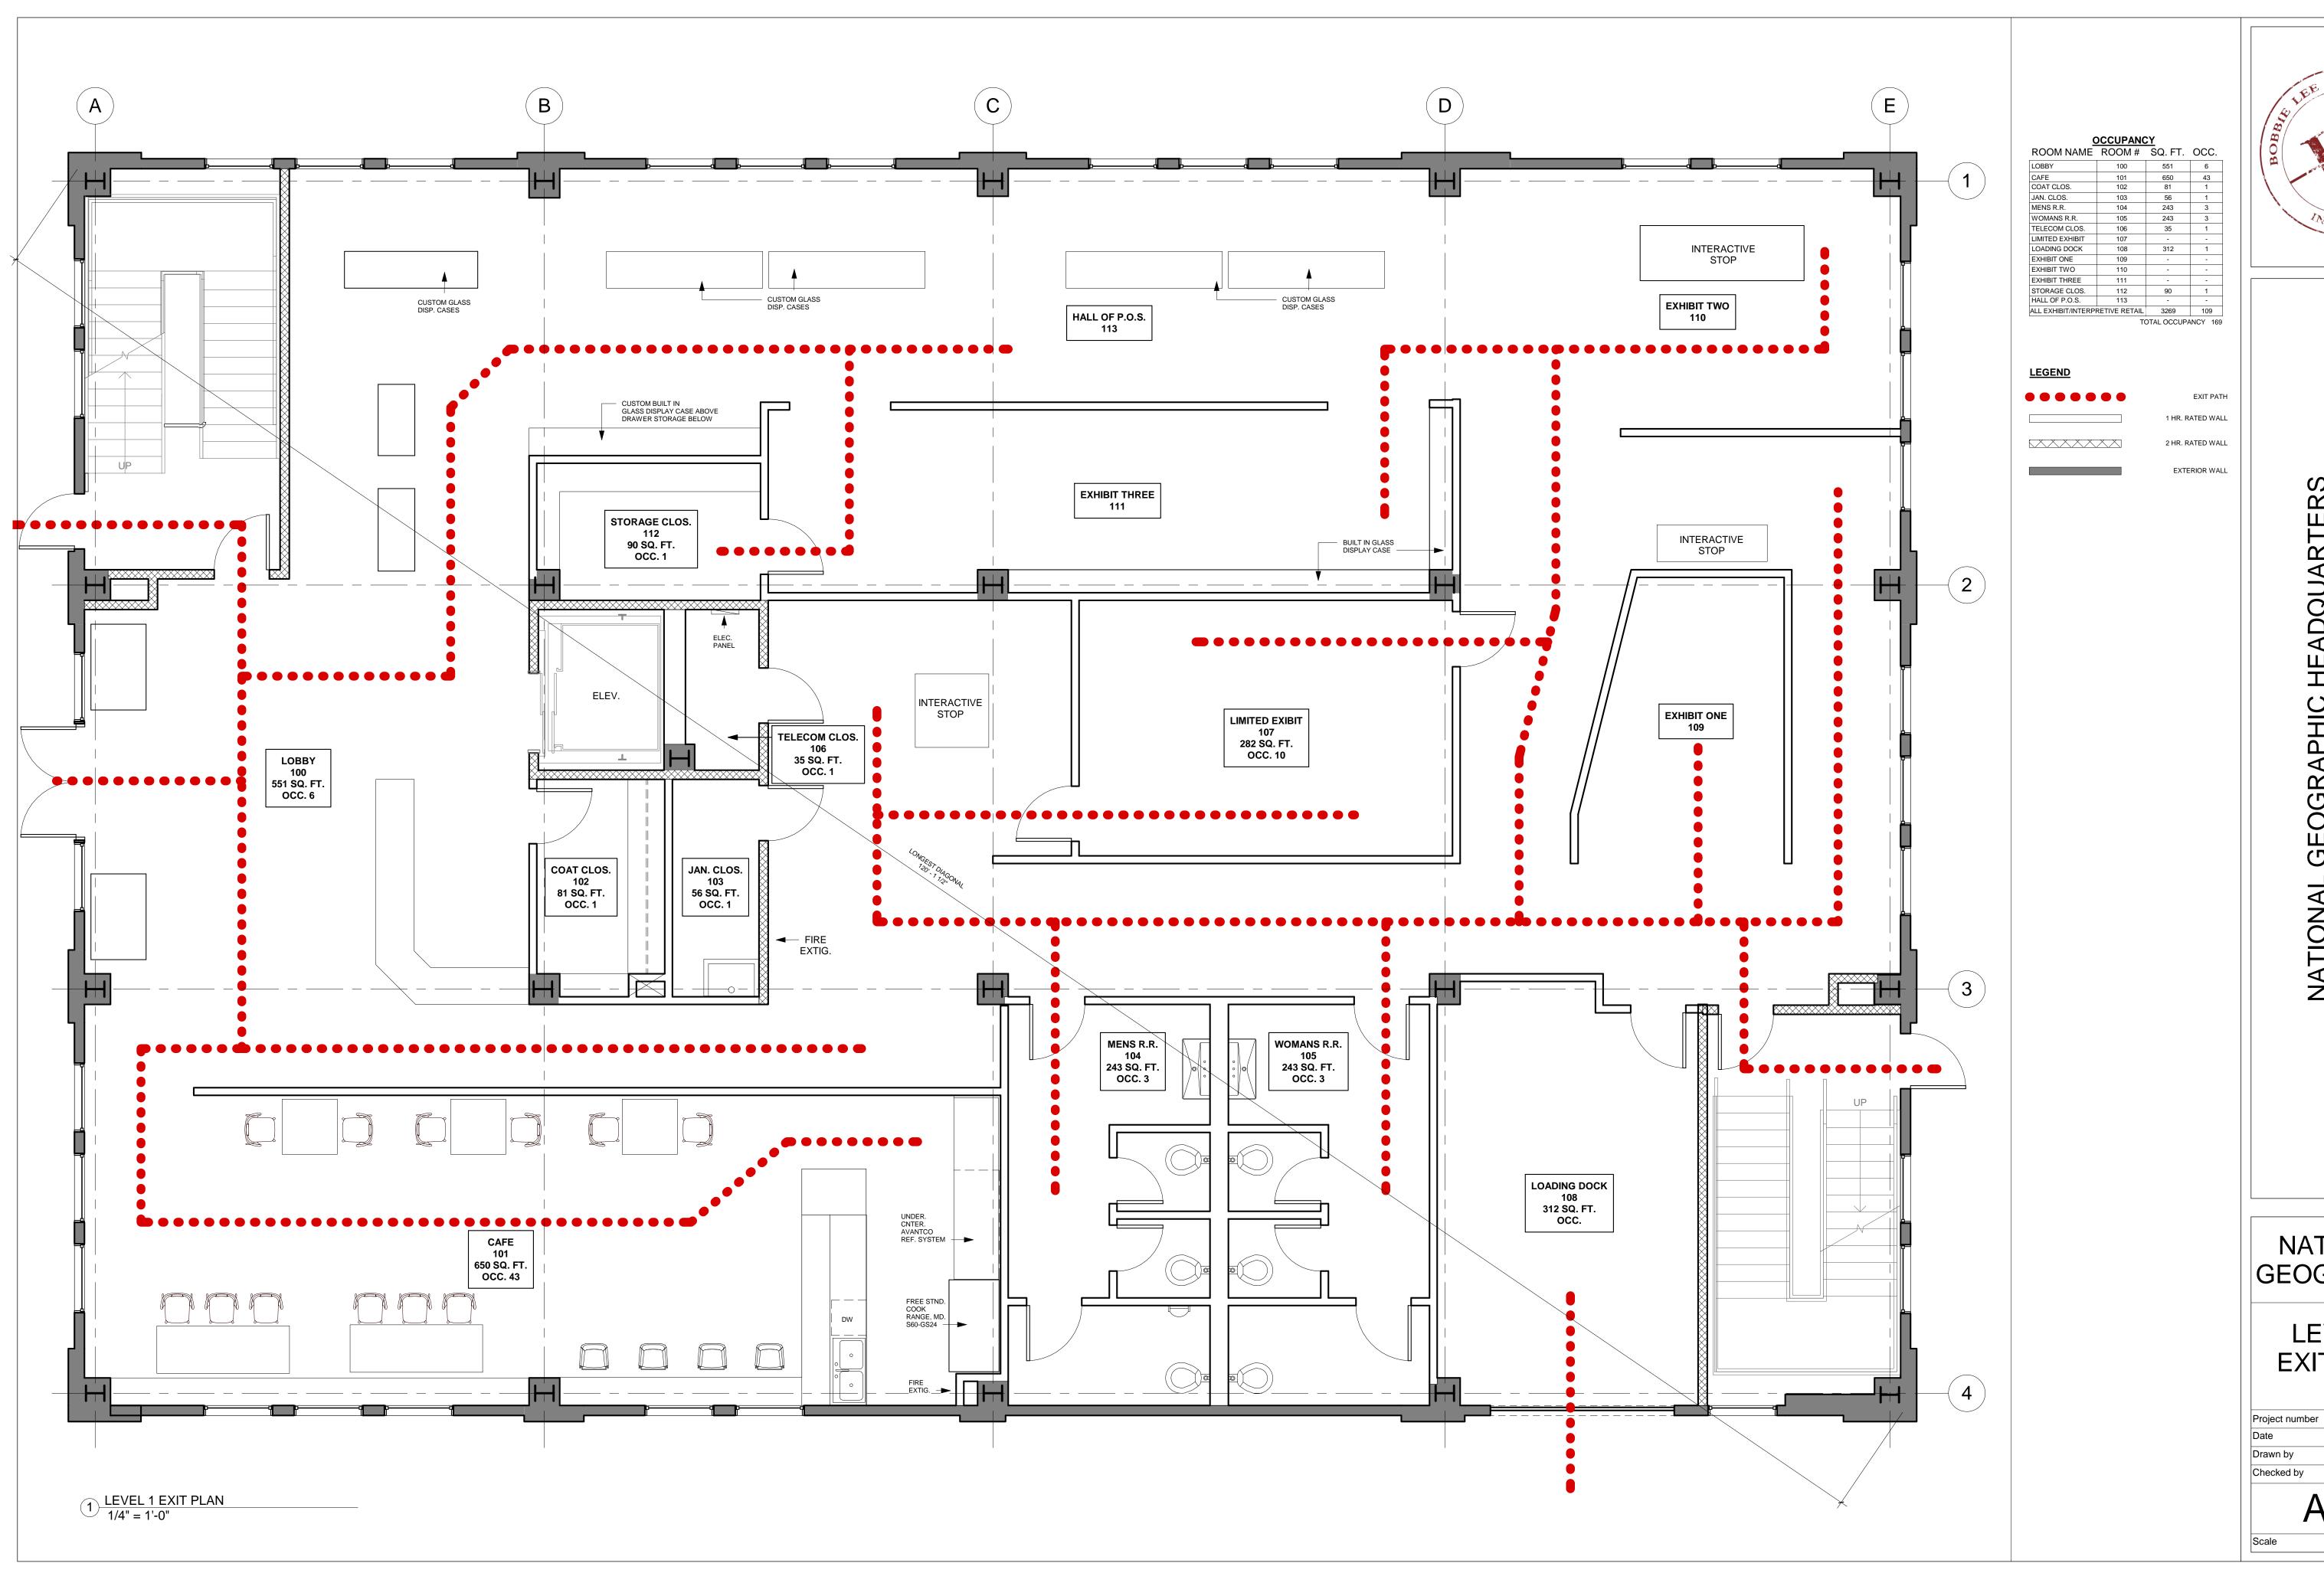




NATIONAL GEOGRAPHIC

LEVEL 1
EXIT PLAN

Project number 00004

tate MAY 25, 2017
rawn by BLH
hecked by SS


1/4" = 1'-0"

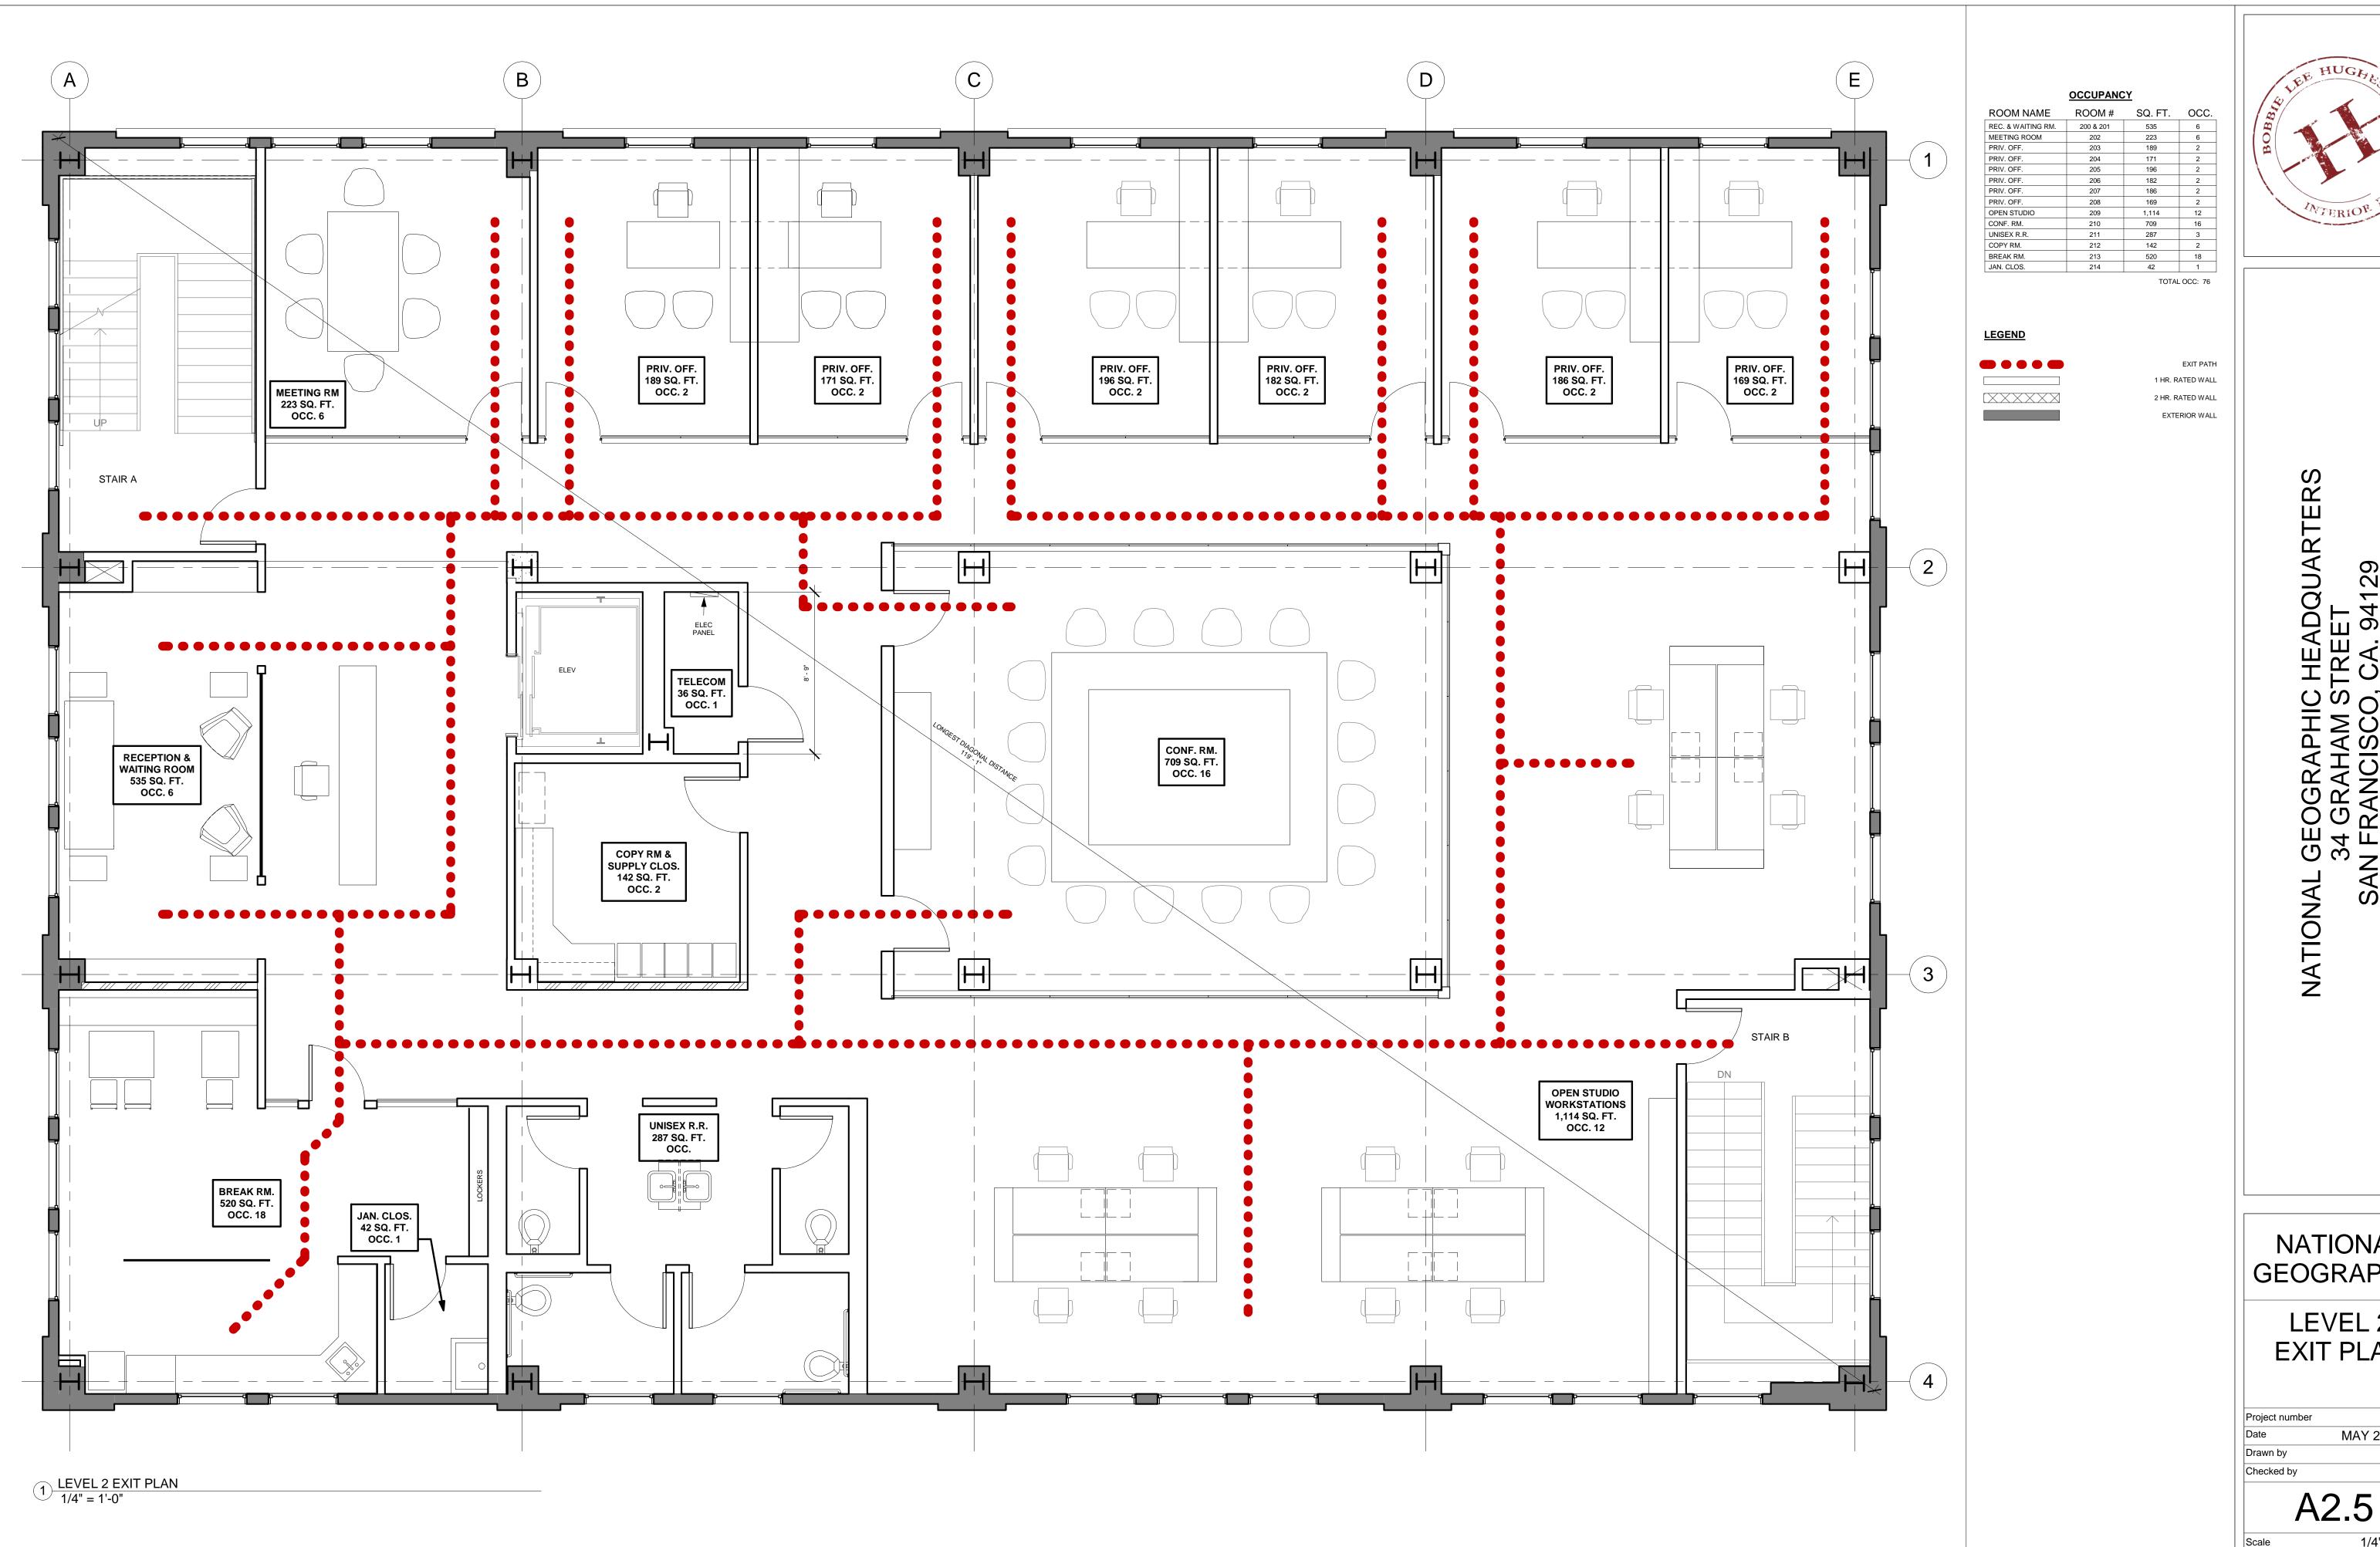



NATIONAL GEOGRAPHIC LEVEL 2 **EXIT PLAN** 00004 Project number MAY 25, 2017

1/4" = 1'-0"

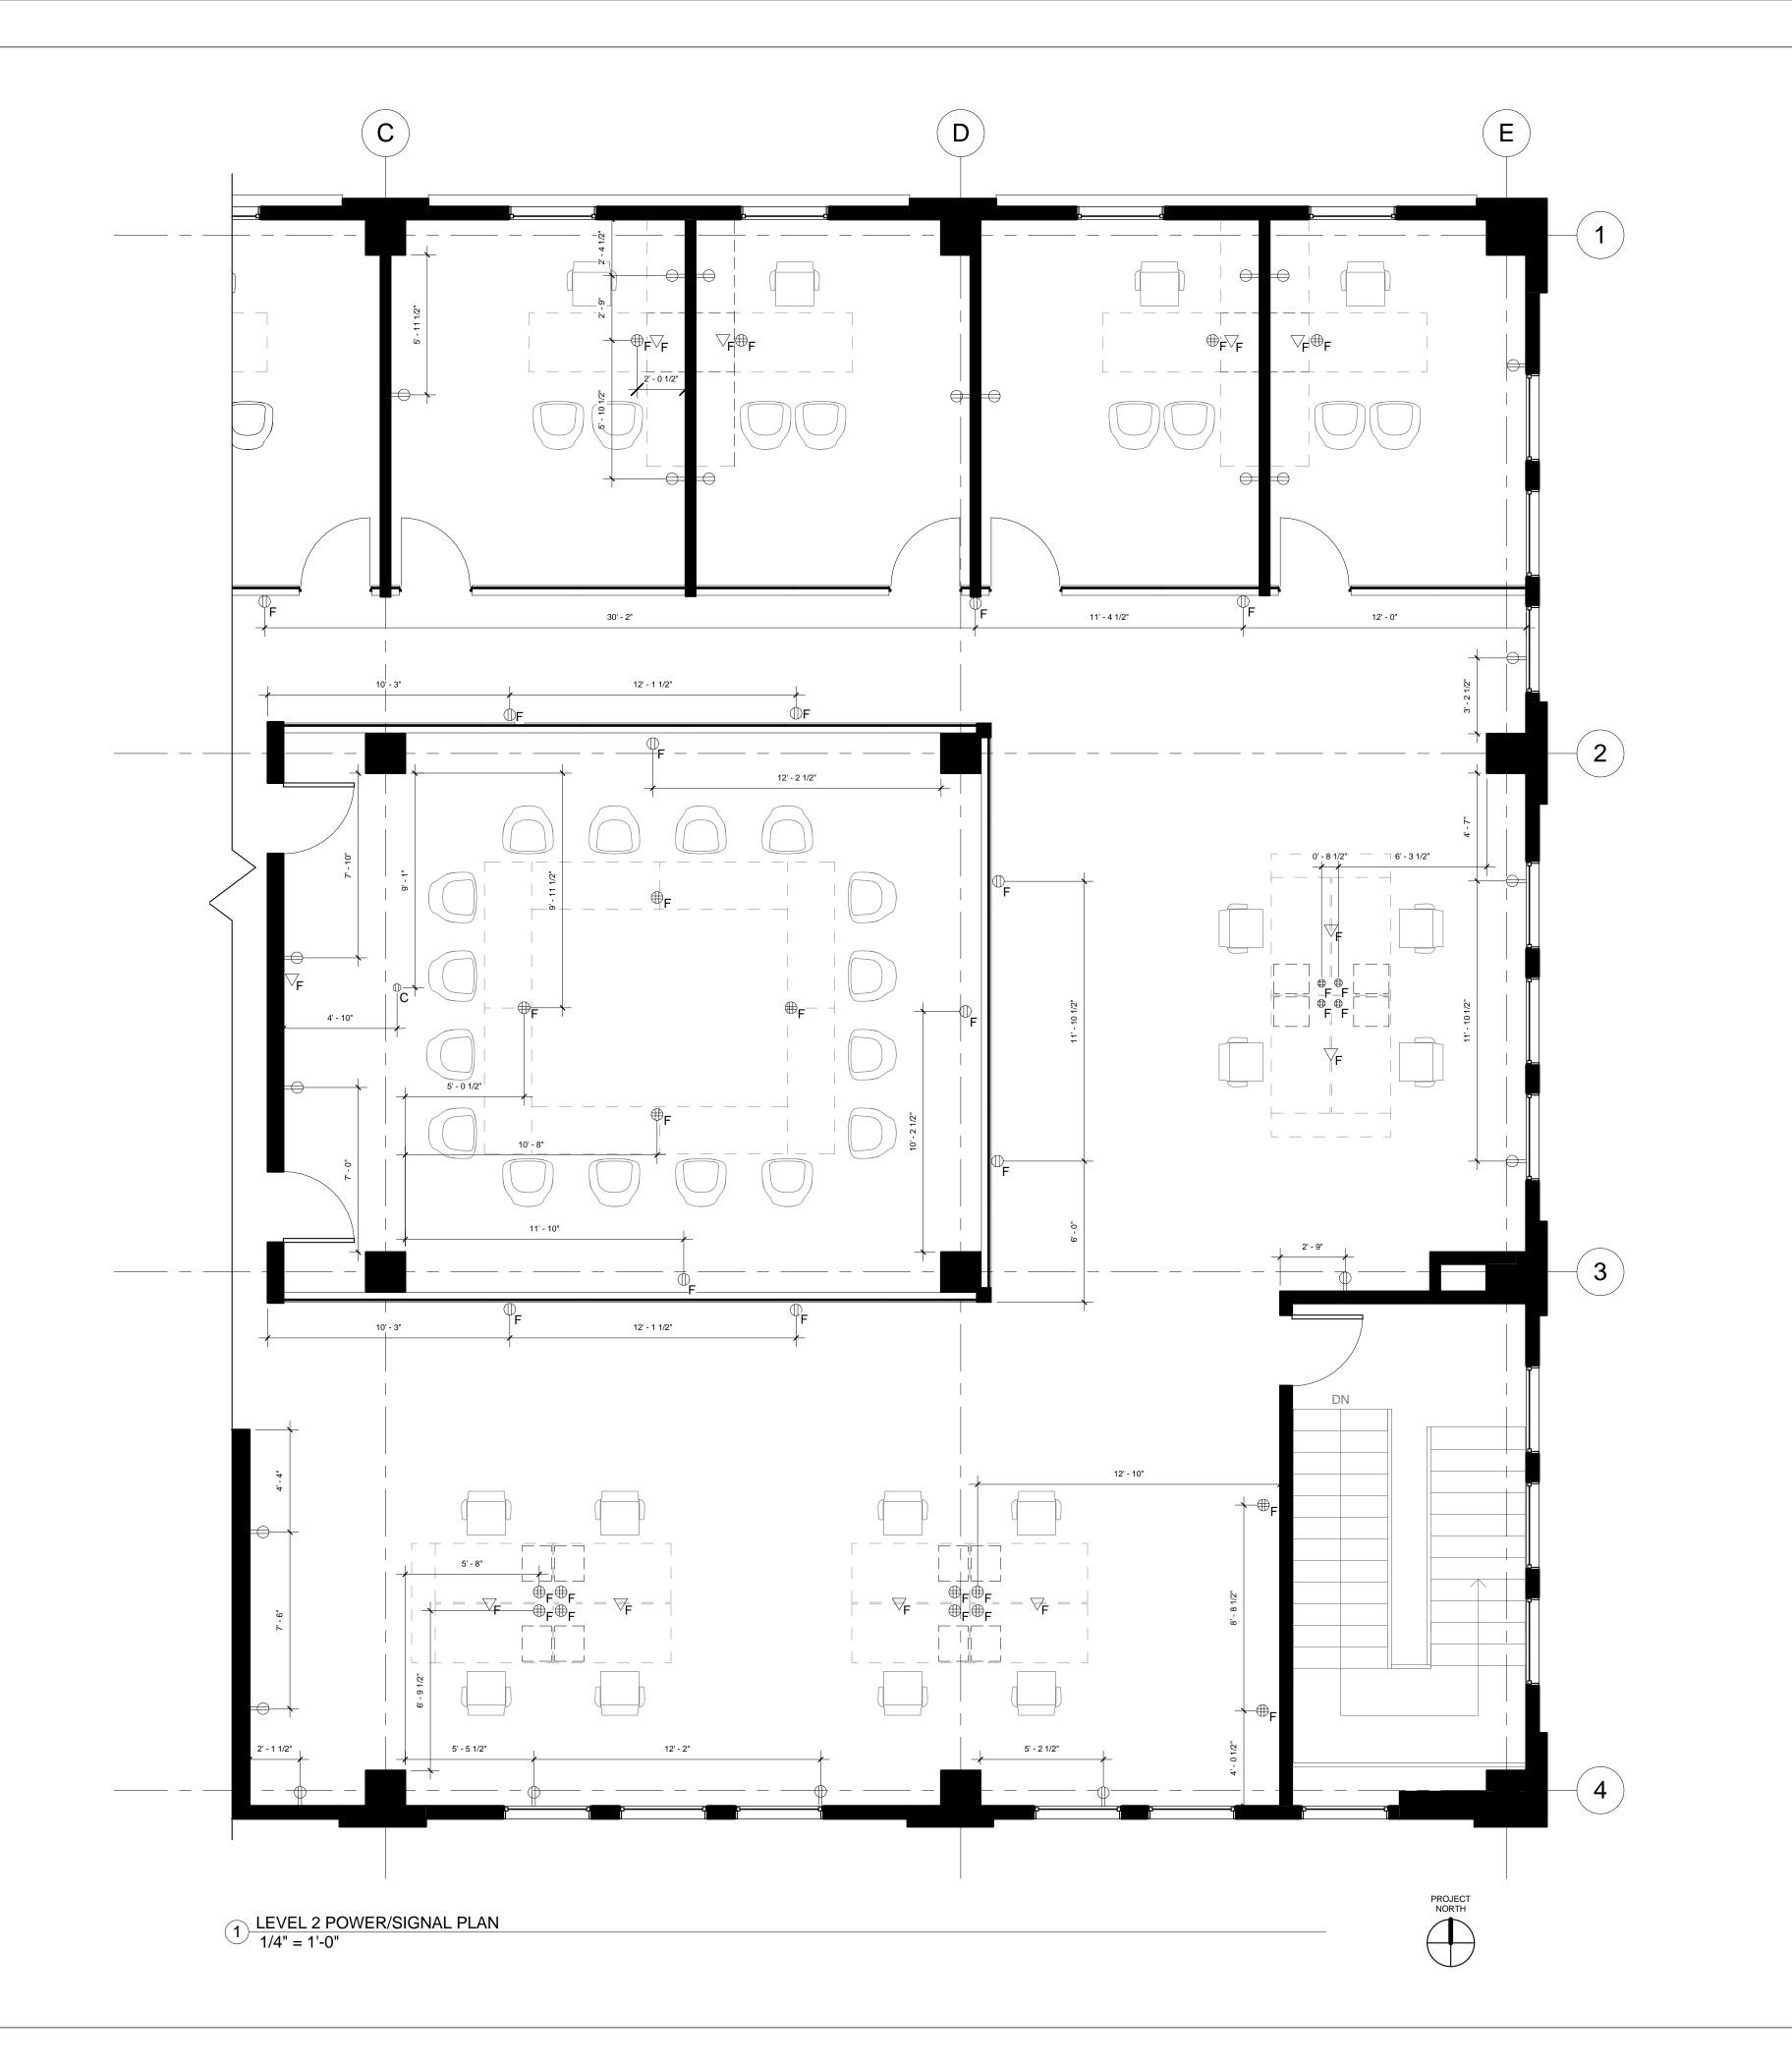

LEGEND

WALL MNT. DUPLEX

□F

FLOOR MNT. DUPLEX

□C

CEILING MNT. DUPLEX

□C

FLOOR MNT. DUPLEX

WIERIOR WEST

ADQUARTERS

NATIONAL

S

POWER/SIGNAL NOTES

ALL WALL MOUNTED OUTLETS AT 18" A.F.F. UNLESS OTHERWISE NOTED.

 ALL CEILING MOUNTED AND FLOOR MOUNTED OUTLETS & DATA TO BE FLUSH UNLESS OTHER WISE NOTED.

NATIONAL GEOGRAPHIC

LEVEL TWO
POWER/SIGNAL
PLAN

Project number 00004


Date MAY 25, 2017

Drawn by BLH

Checked by SS

A2.6

1/4" = 1'-0"

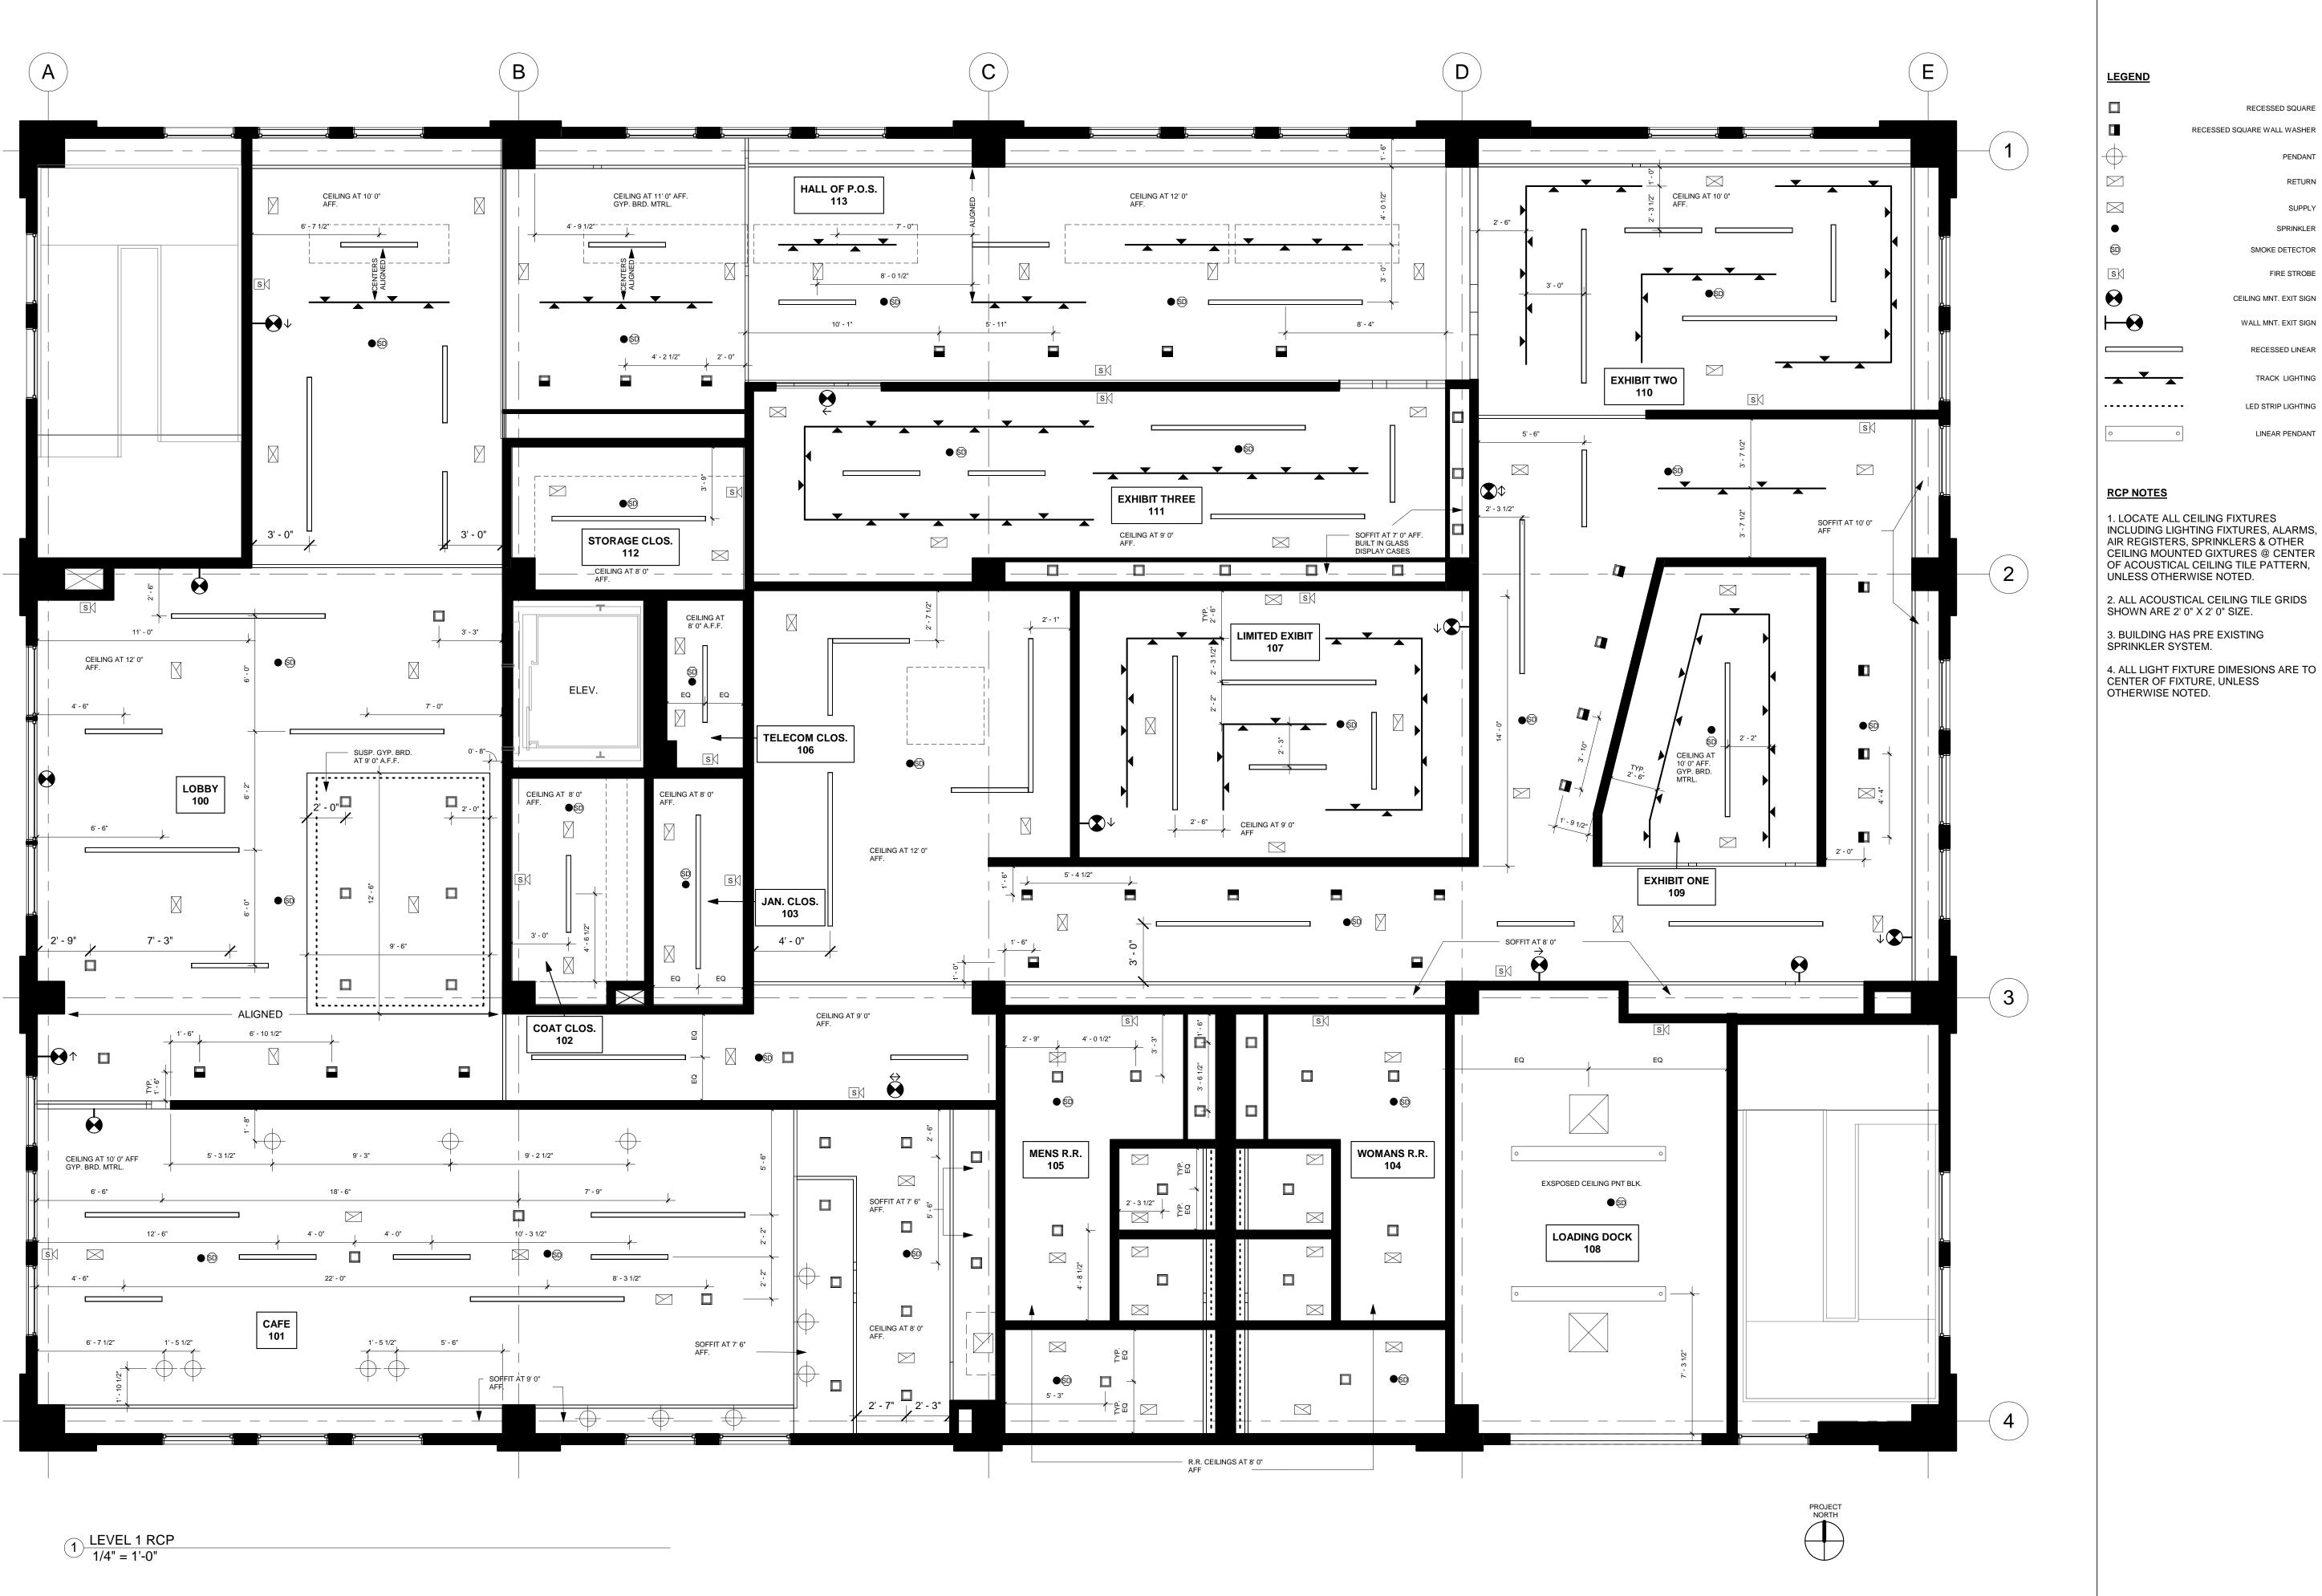



NATIONAL GEOGRAPHIC HEADQUARTERS 34 GRAHAM STREET SAN FRANCISCO, CA. 94129

NATIONAL GEOGRAPHIC

LEVEL 1 RCP

Project number 00004


Date MAY 25, 2017

Drawn by BLH

Checked by SS

A3.0

Scale 1/4" = 1'-0"

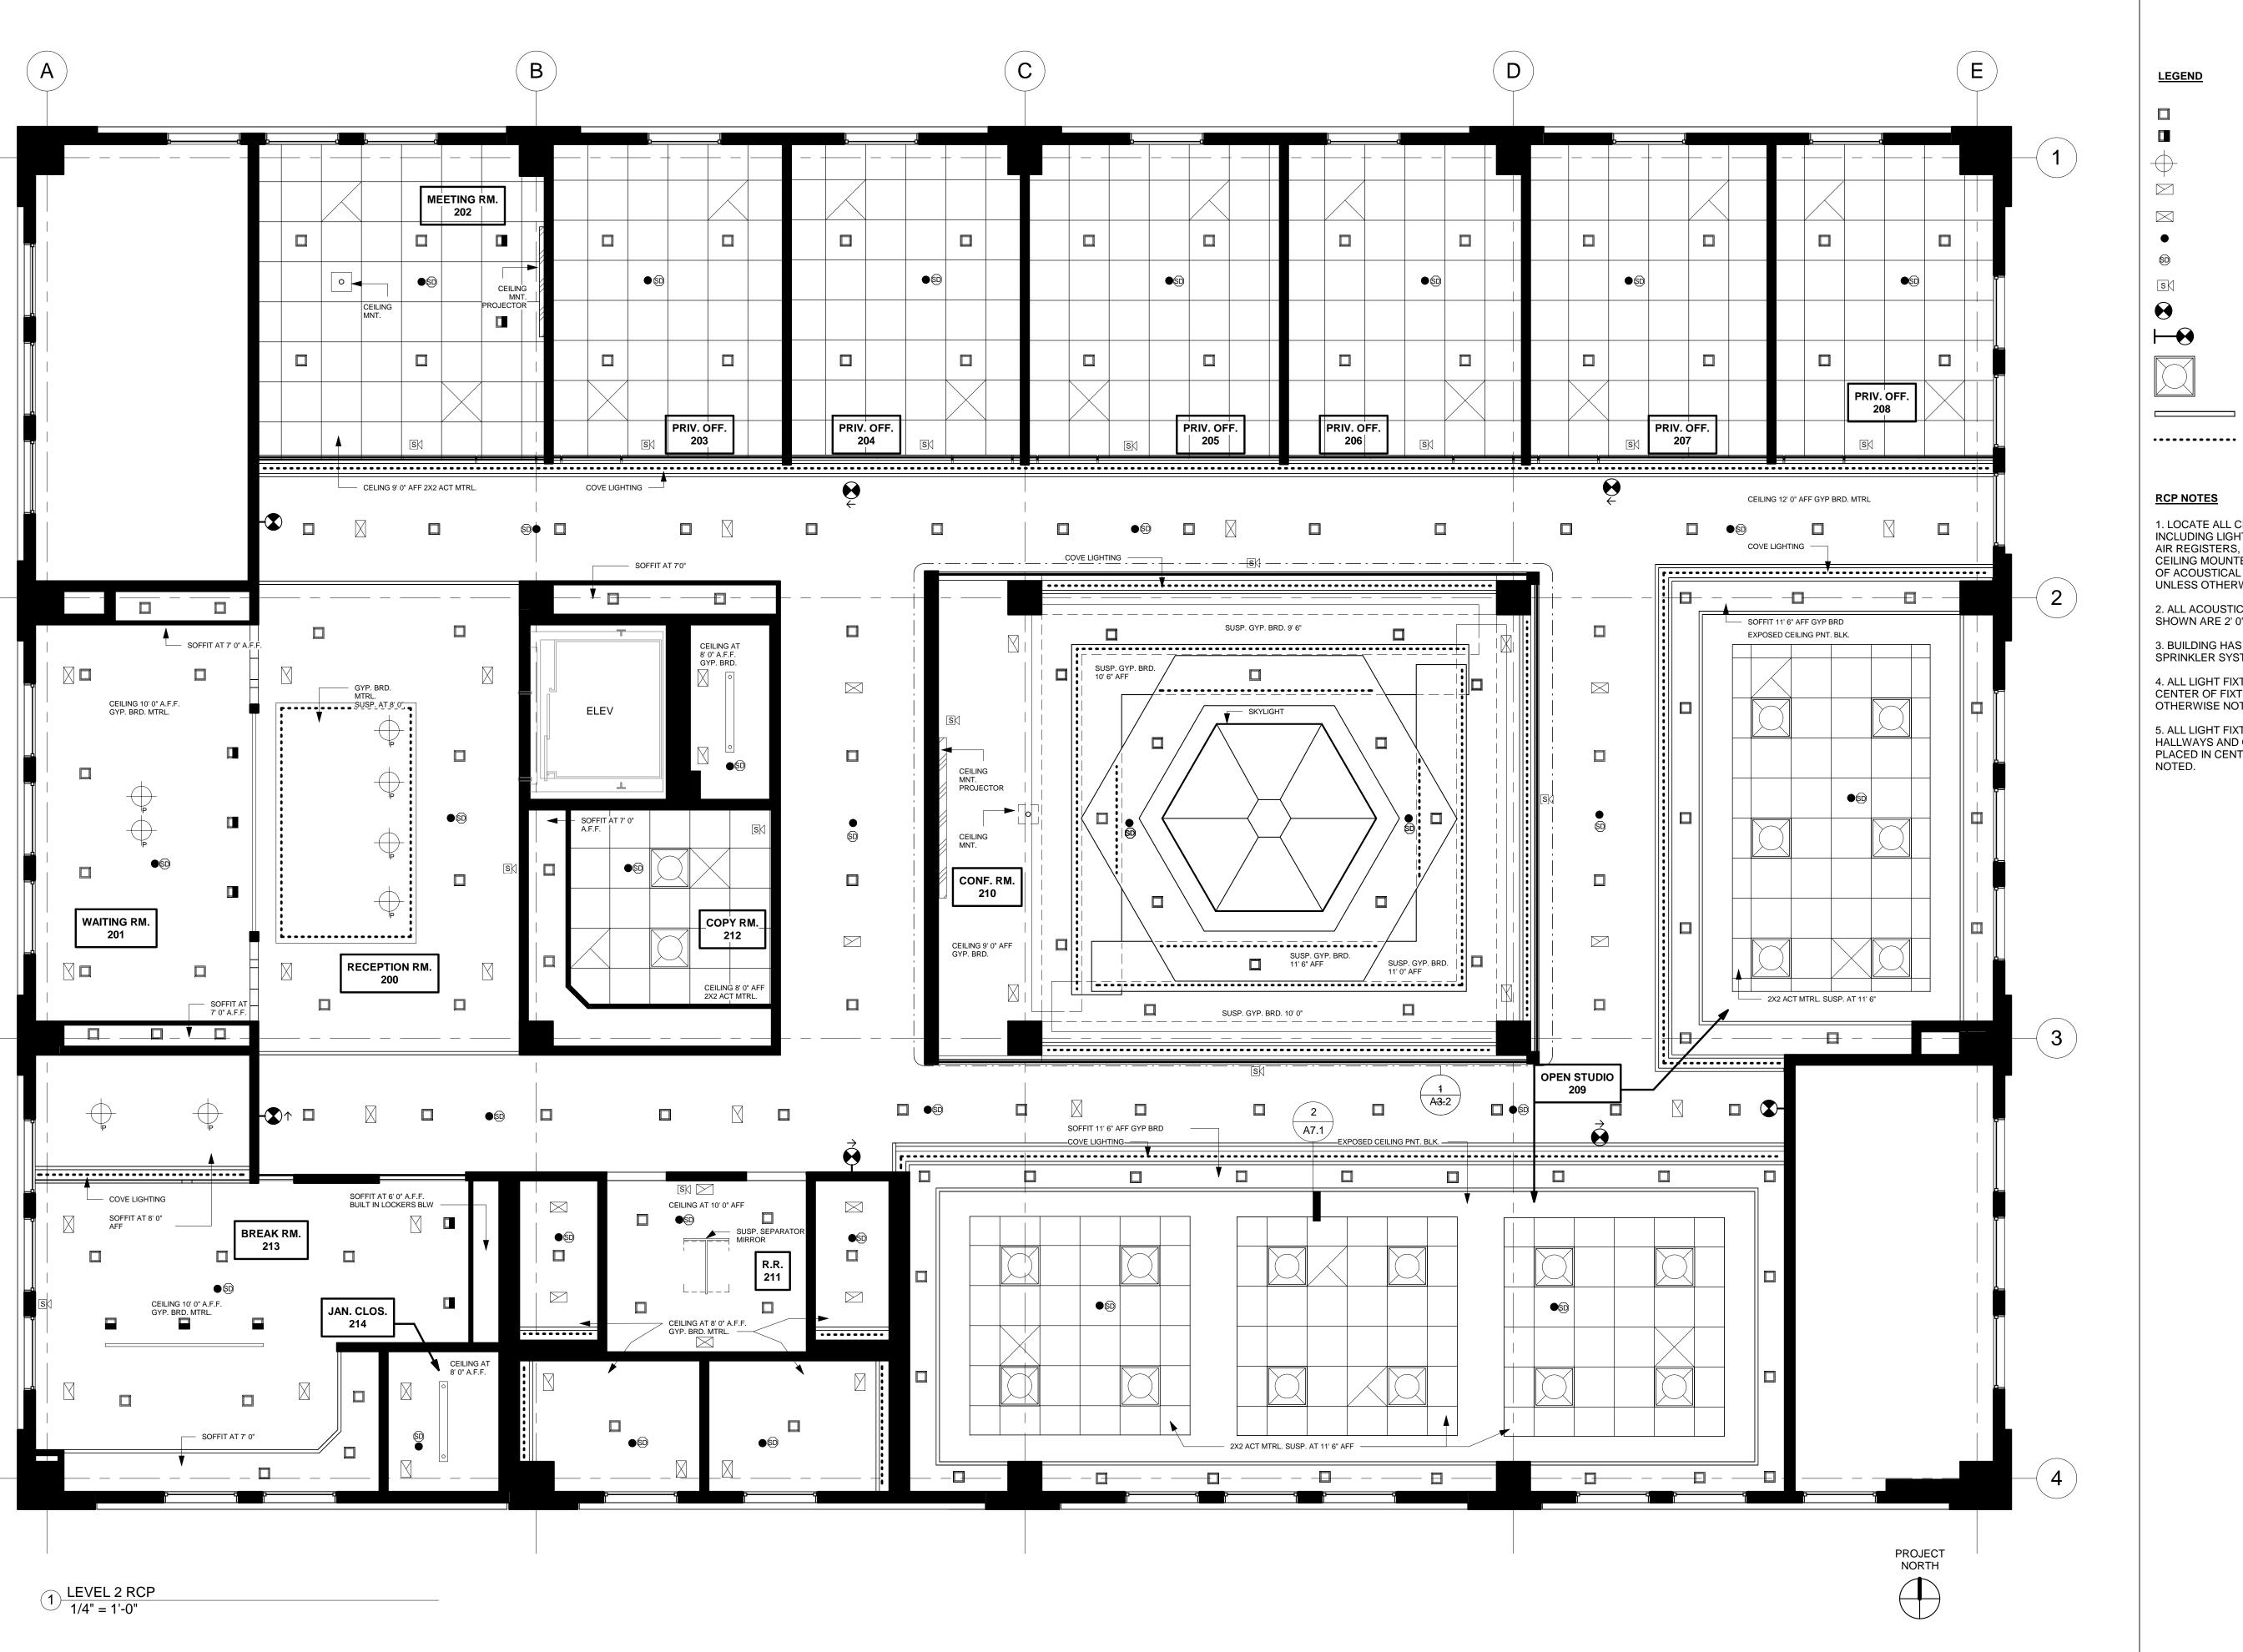

RECESSED SQUARE RECESSED SQUARE WALL WASHER PENDANT RETURN

SUPPLY SPRINKLER SMOKE DETECTOR FIRE STROBE

CEILING MNT. EXIT SIGN WALL MNT. EXIT SIGN

TROFFER LIGHT RECESSED LINEAR

LED LIGHTING

RCP NOTES

1. LOCATE ALL CEILING FIXTURES INCLUDING LIGHTING FIXTURES, ALARMS, AIR REGISTERS, SPRINKLERS & OTHER CEILING MOUNTED GIXTURES @ CENTER OF ACOUSTICAL CEILING TILE PATTERN, UNLESS OTHERWISE NOTED.

2. ALL ACOUSTICAL CEILING TILE GRIDS SHOWN ARE 2' 0" X 2' 0" SIZE.

3. BUILDING HAS PRE EXISTING SPRINKLER SYSTEM.

4. ALL LIGHT FIXTURE DIMESIONS ARE TO CENTER OF FIXTURE, UNLESS

OTHERWISE NOTED.

5. ALL LIGHT FIXTURES LOCATED IN HALLWAYS AND ON SOFFITS ARE TO BE PLACED IN CENTER UNLESS OTHERWISE


NATIONAL GEOGRAPHIC

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LEVEL 2 RCP

00004 Project number MAY 25, 2017 Drawn by Checked by

A3.1 1/4" = 1'-0"

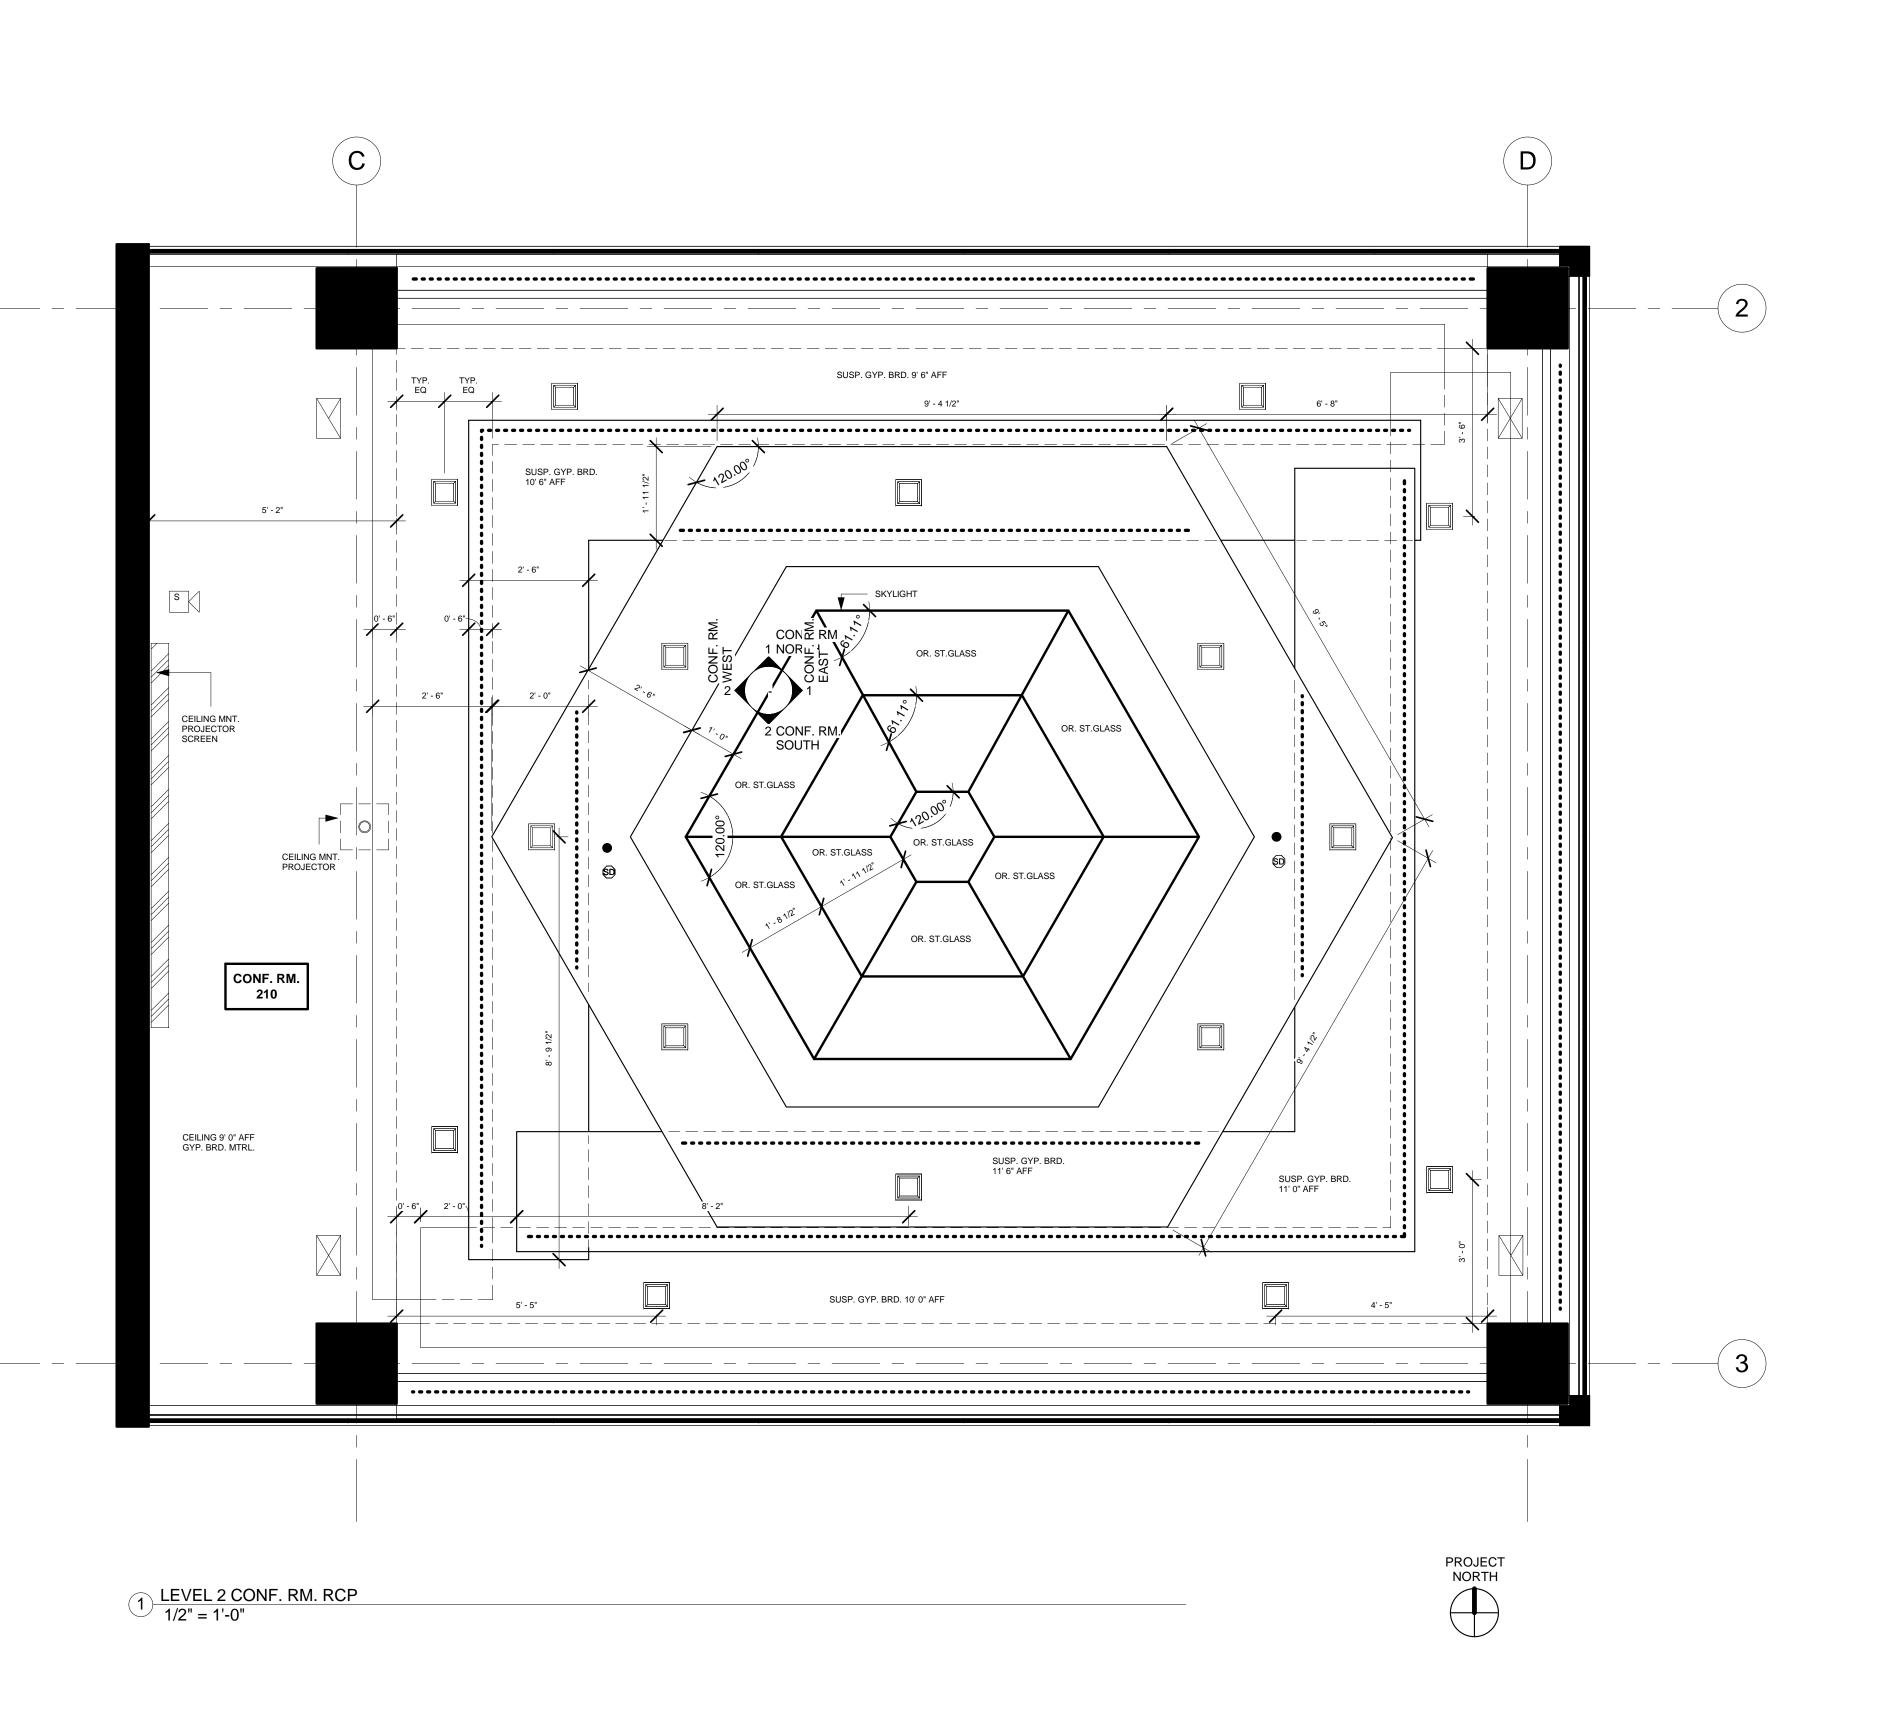


ATIONAL GEOGRAPHIC HEADQUARTERS 34 GRAHAM STREET SAN FRANCISCO, CA. 94129

NATIONAL GEOGRAPHIC

LEVEL 2
CONF. RM.
RCP


Project number 00004
Date MAY 25, 2017
Drawn by BLH
Checked by SS


1/2" = 1'-0"

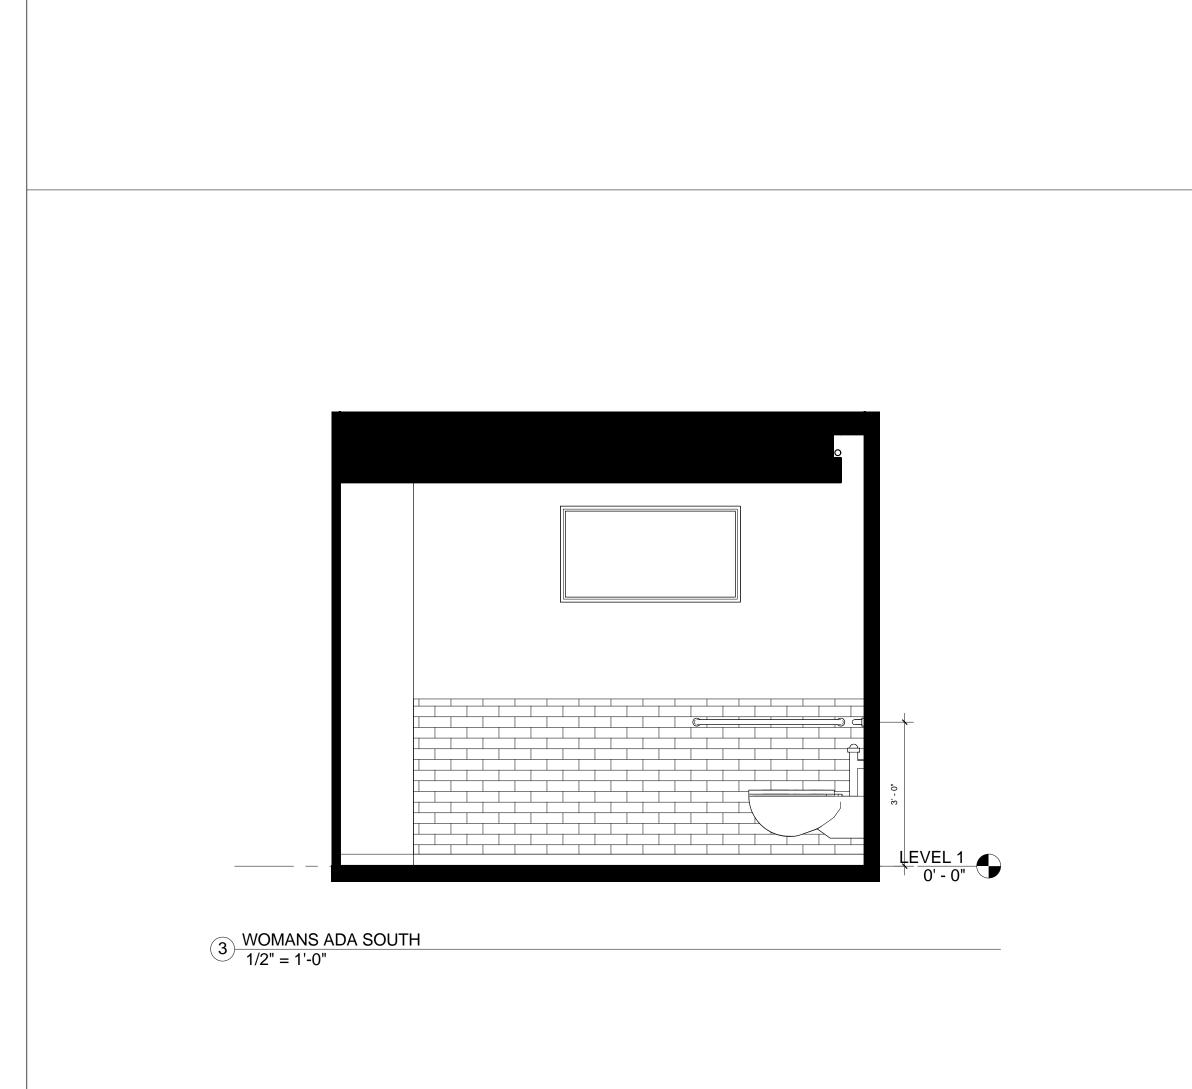



ø 5' - 0"

1 LEVEL 1 WOMANS ADA R.R. 1/2" = 1'-0"

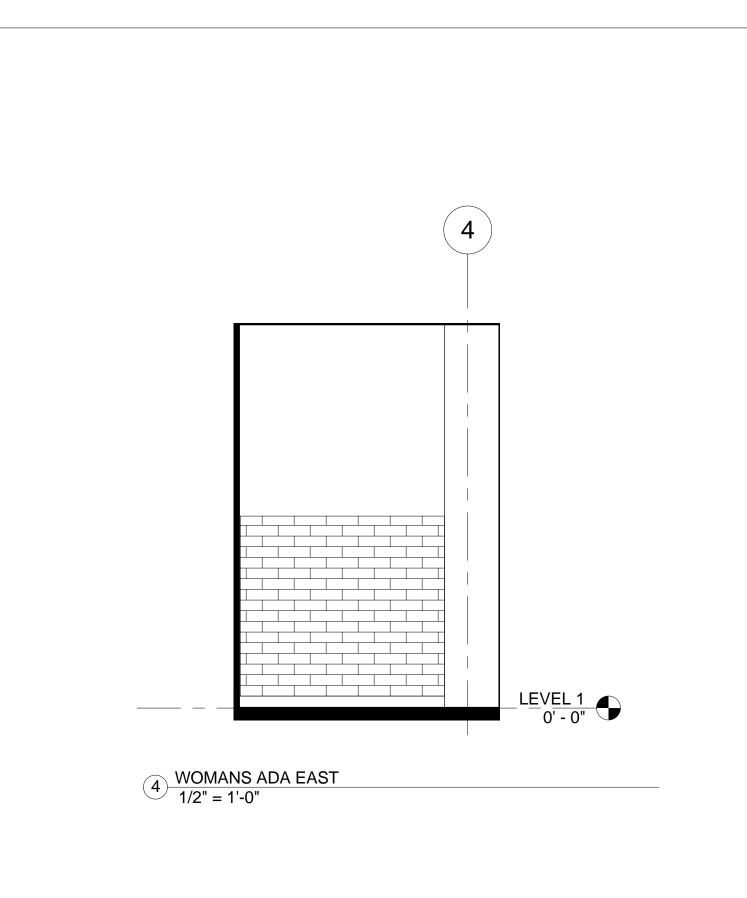

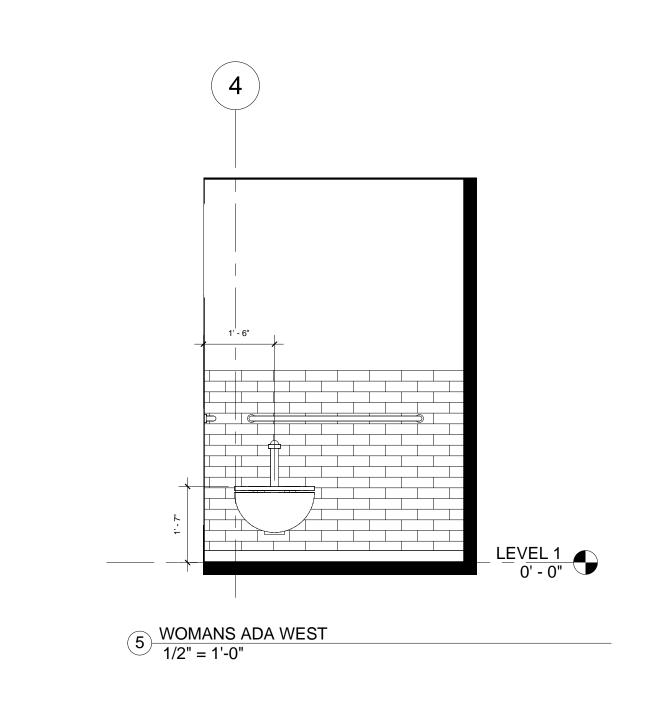

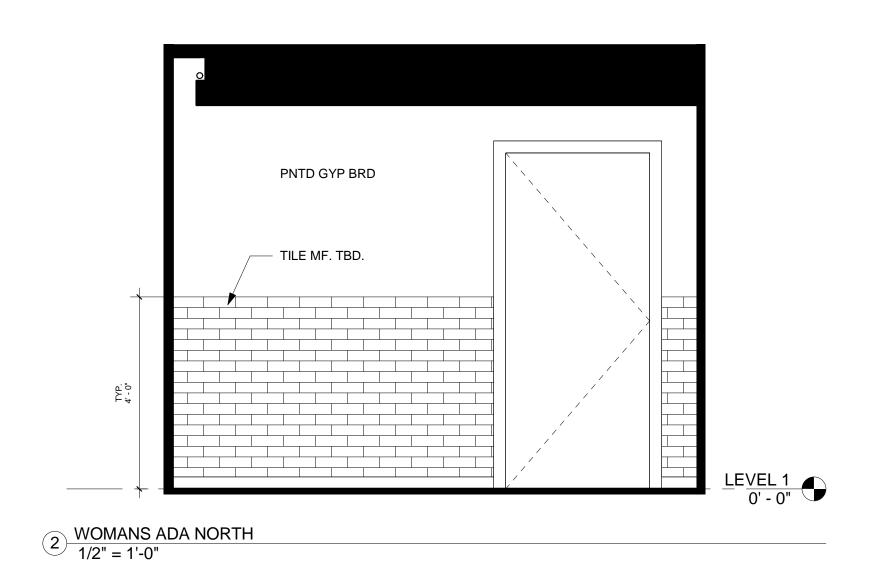

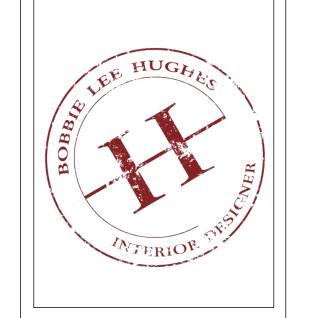

:ADQUARTERS EET

NAL GEOGRAPHIC 34 GRAHAM S' SAN FRANCISCO,

NATIONAL

NATIONAL GEOGRAPHIC

LEVEL 1
WOMANS
ADA RR.

Project number 00004

WOMANS
ADA RR.

Project number 00004


Date MAY 25, 2017

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Checked by SS

1/2" = 1'-0"

Scale



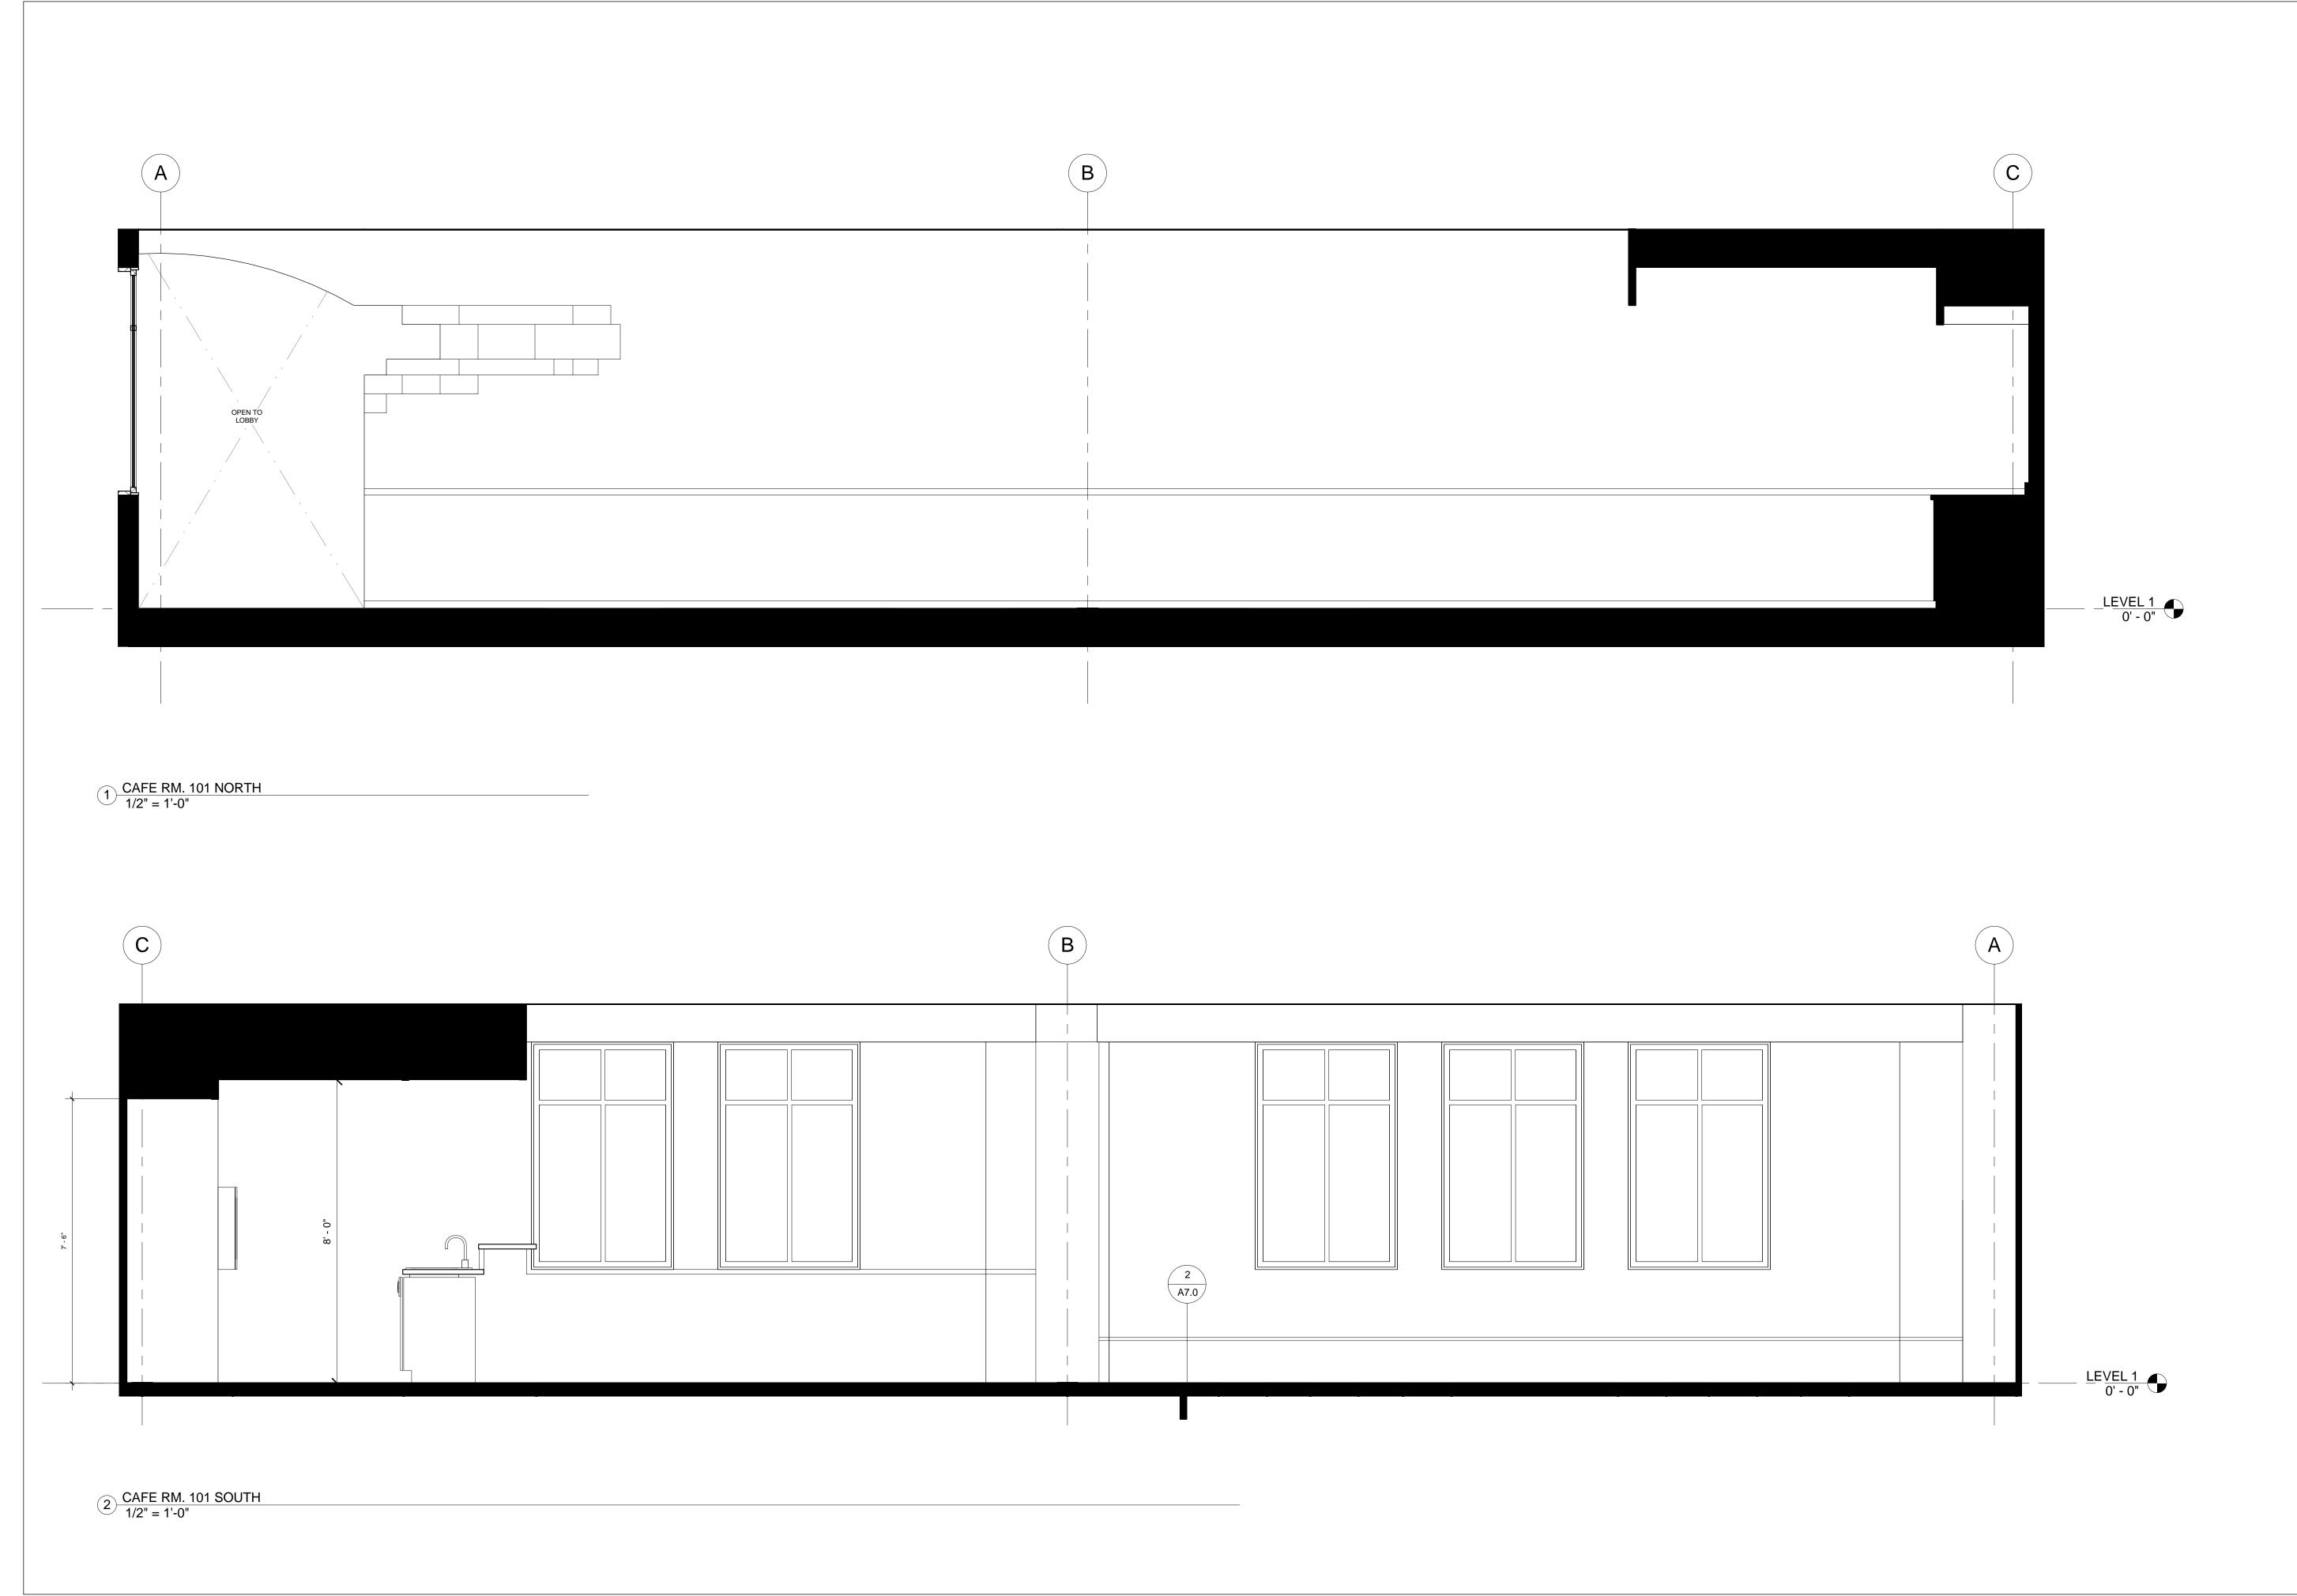

NATIONAL GEOGRAPHIC

INTERIOR ELEVATIONS

Project number 00004

Date MAY 25, 2017


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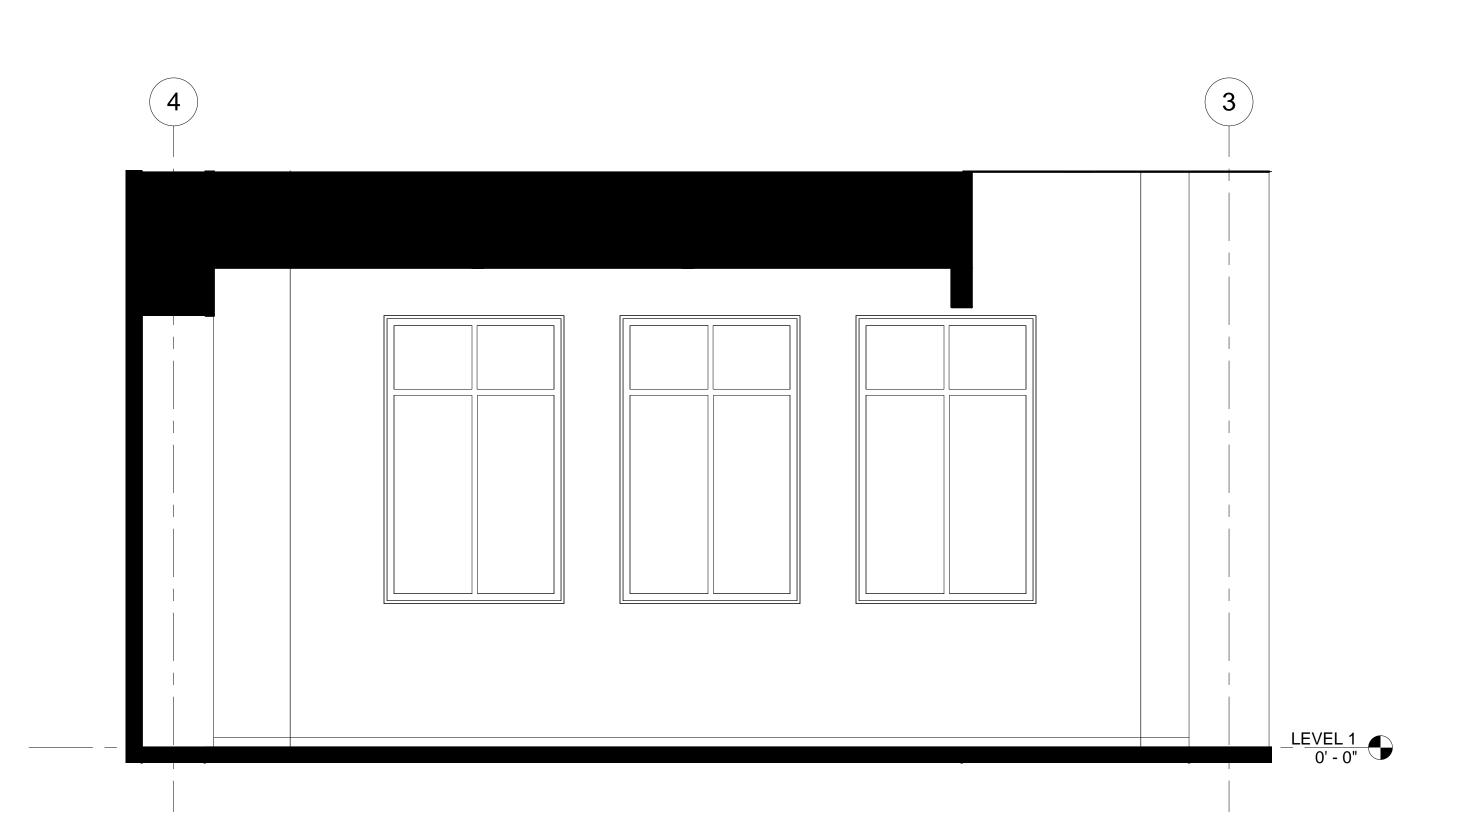
Checked by SS

A5.0Scale 1/2" = 1'-0"


1 CAFE RM. 101 EAST 1/2" = 1'-0"

3 HALL OF P.O.S. RM. 113 EAST 1/2" = 1'-0"



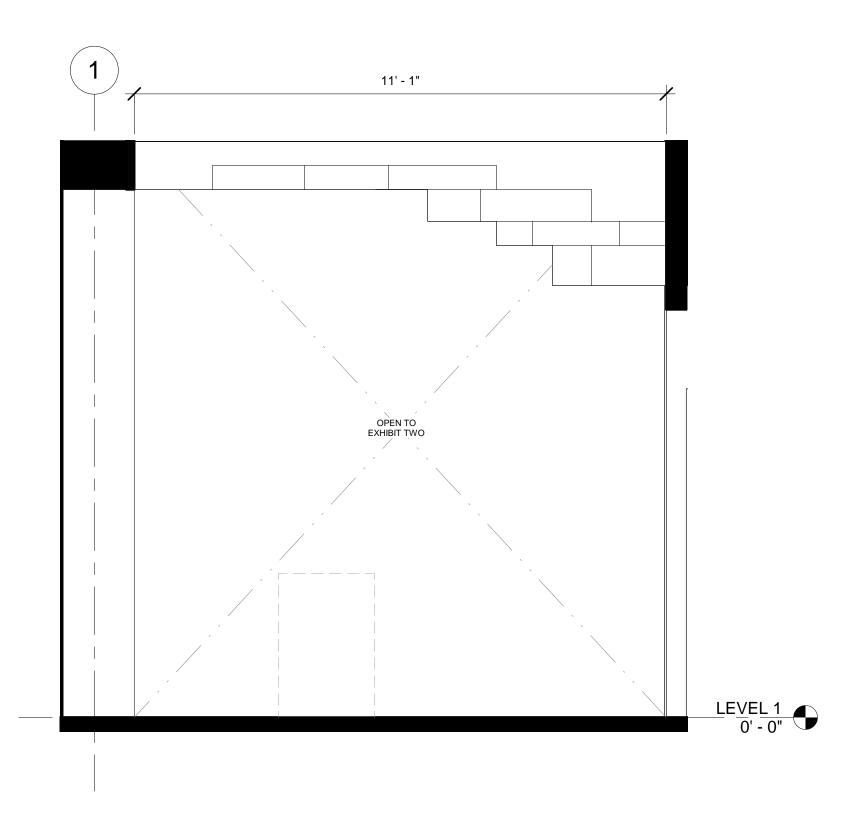

2 CAFE RM. 101 WEST 1/2" = 1'-0"

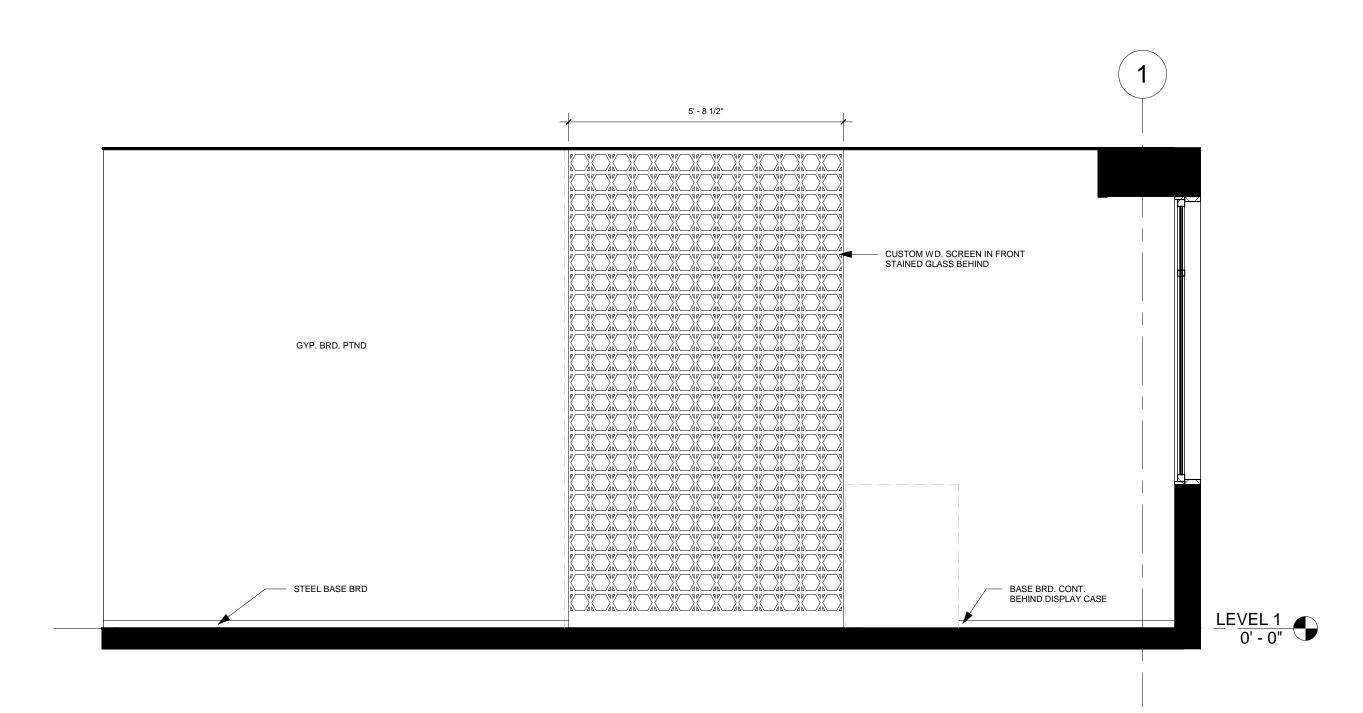

4 HALL OF P.O.S. RM. 113 WEST 1/2" = 1'-0"



NATIONAL GEOGRAPHIC


INTERIOR ELEVATIONS

Project number 00004
Date MAY 25, 2017
Drawn by BLH
Checked by SS

A5.1

1/2" = 1'-0"

Scale

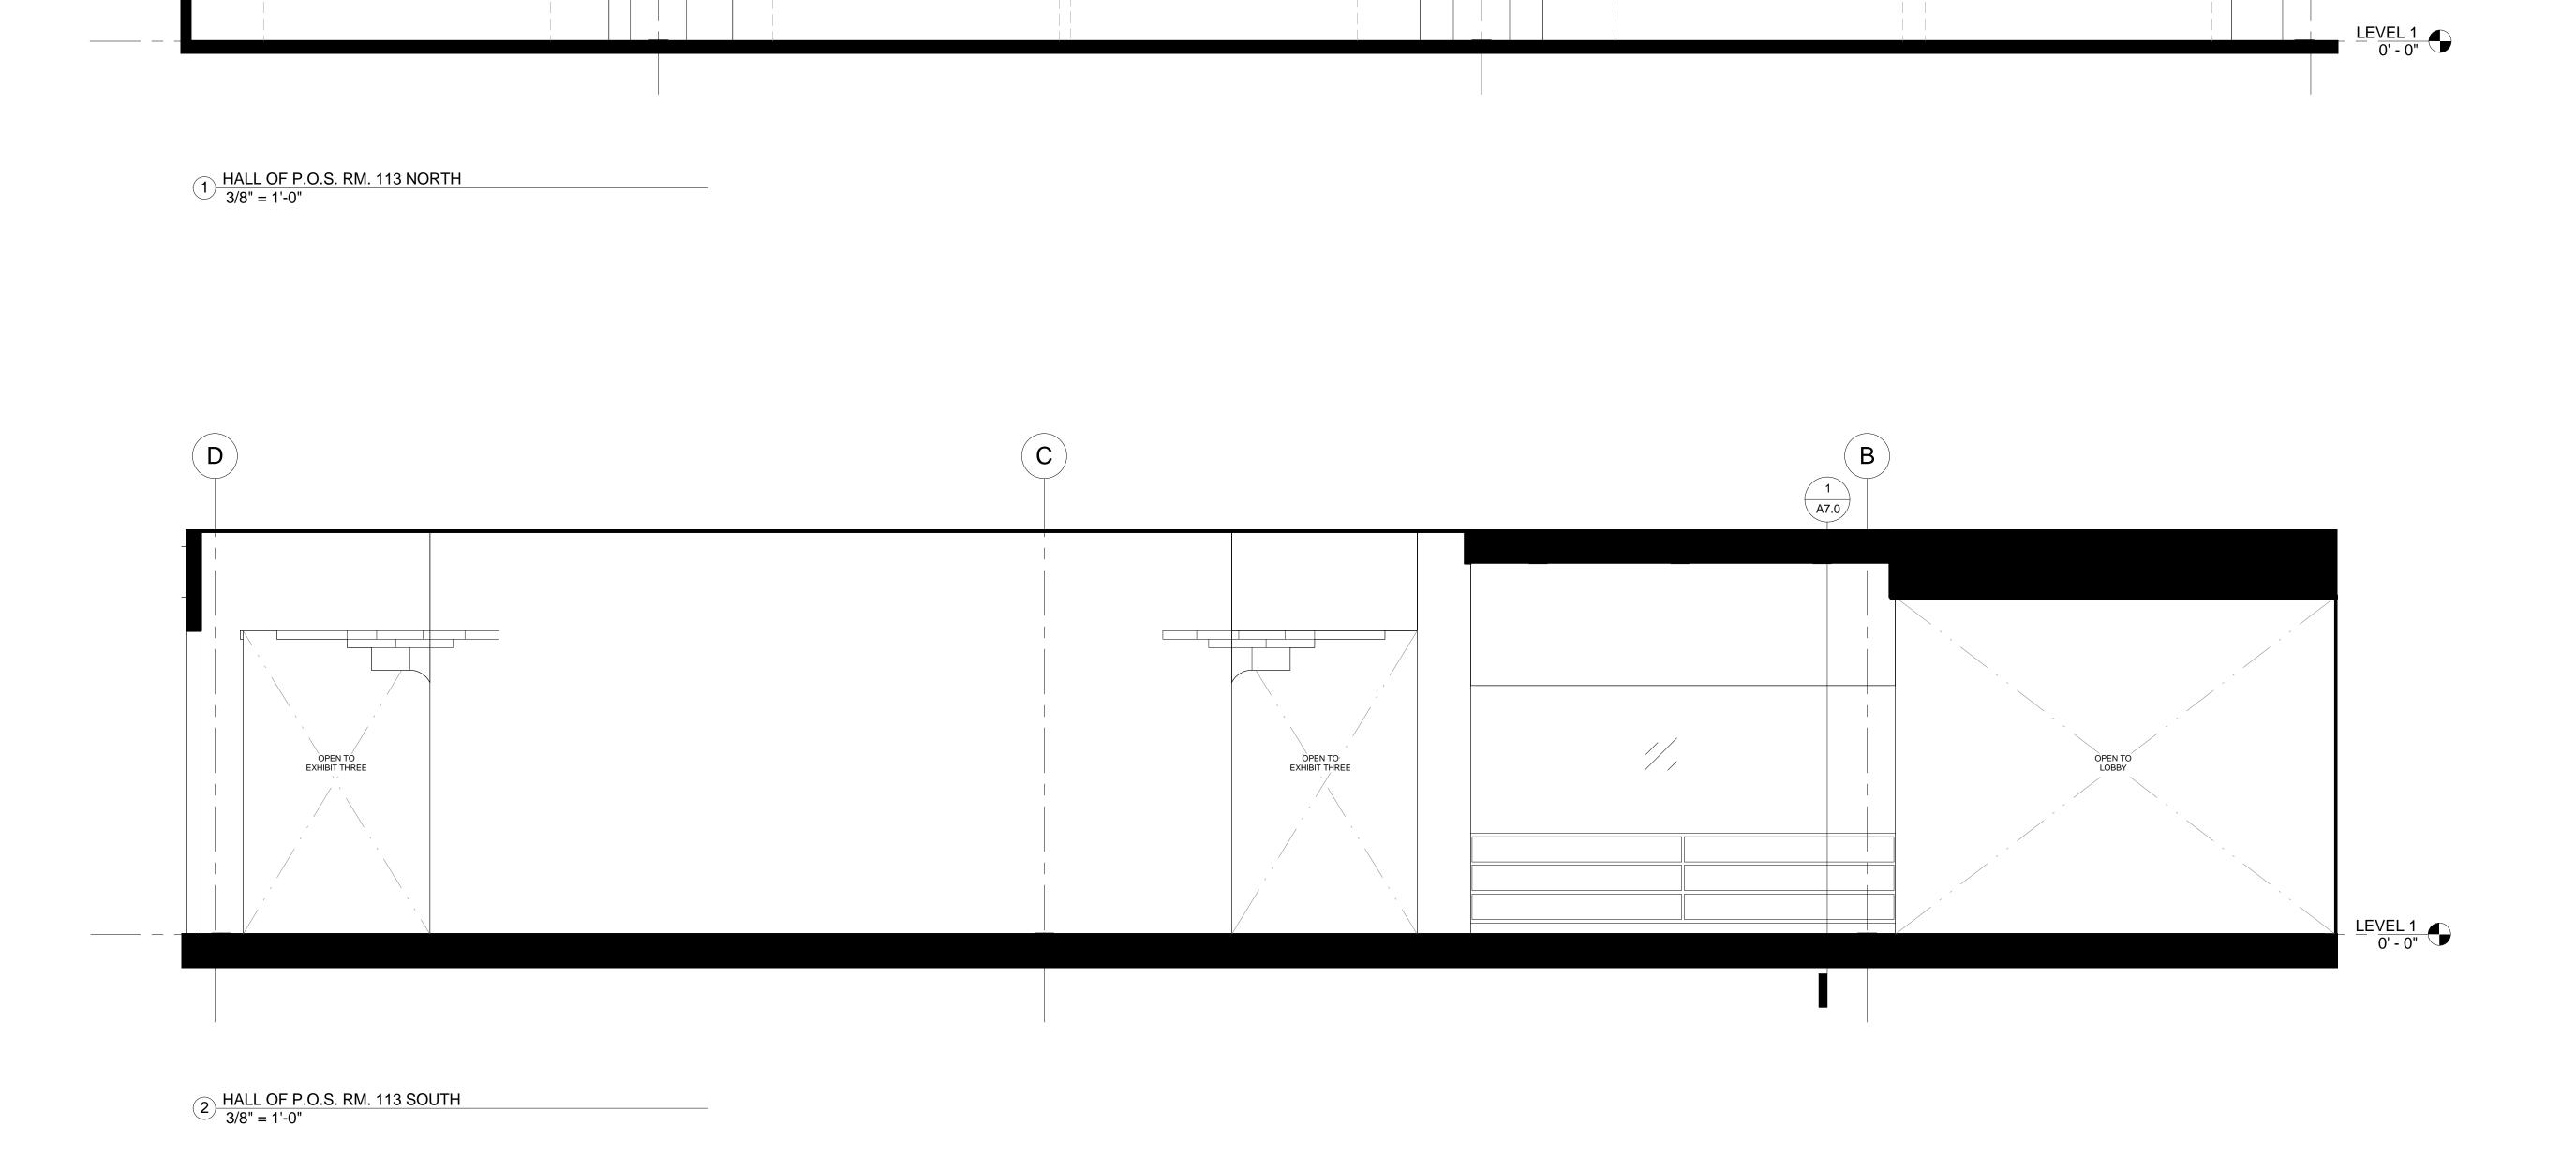

C

NAL GEOGRAPHIC HEADQUARTERS 34 GRAHAM STREET SAN FRANCISCO, CA. 94129



NATIONAL

GEOGRAPHIC

INTERIOR

ELEVATIONS

A5.2

Project number


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Scale

00004

MAY 25, 2017

3/8" = 1'-0"

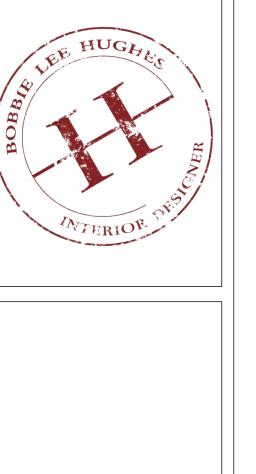

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NATIONAL GEOGRAPHIC

INTERIOR ELEVATIONS

Project number 00004

Date MAY 25, 2017

Project number 00004

Date MAY 25, 2017


Drawn by BLH

Checked by SS


A5.3
Scale 1/2" = 1'-0"


C SOUTH COOK ASSESSED TO SEE THE SECOND SOUTH COOK ASSESSED TO SEC

1 CONF. RM. NORTH 1/2" = 1'-0"

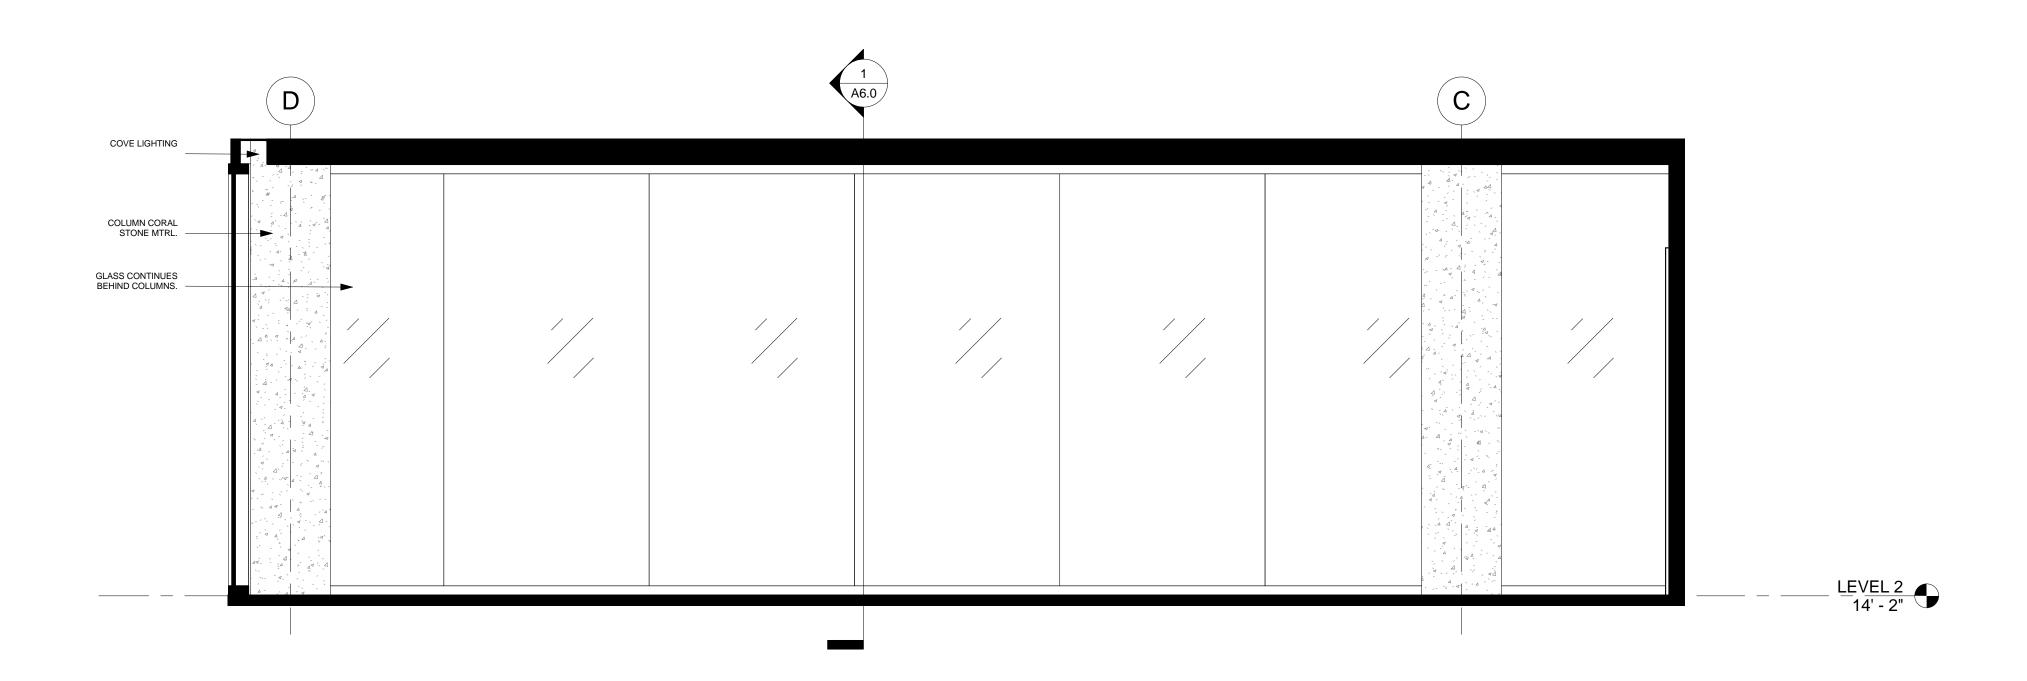

2 CONF. RM. SOUTH
1/2" = 1'-0"

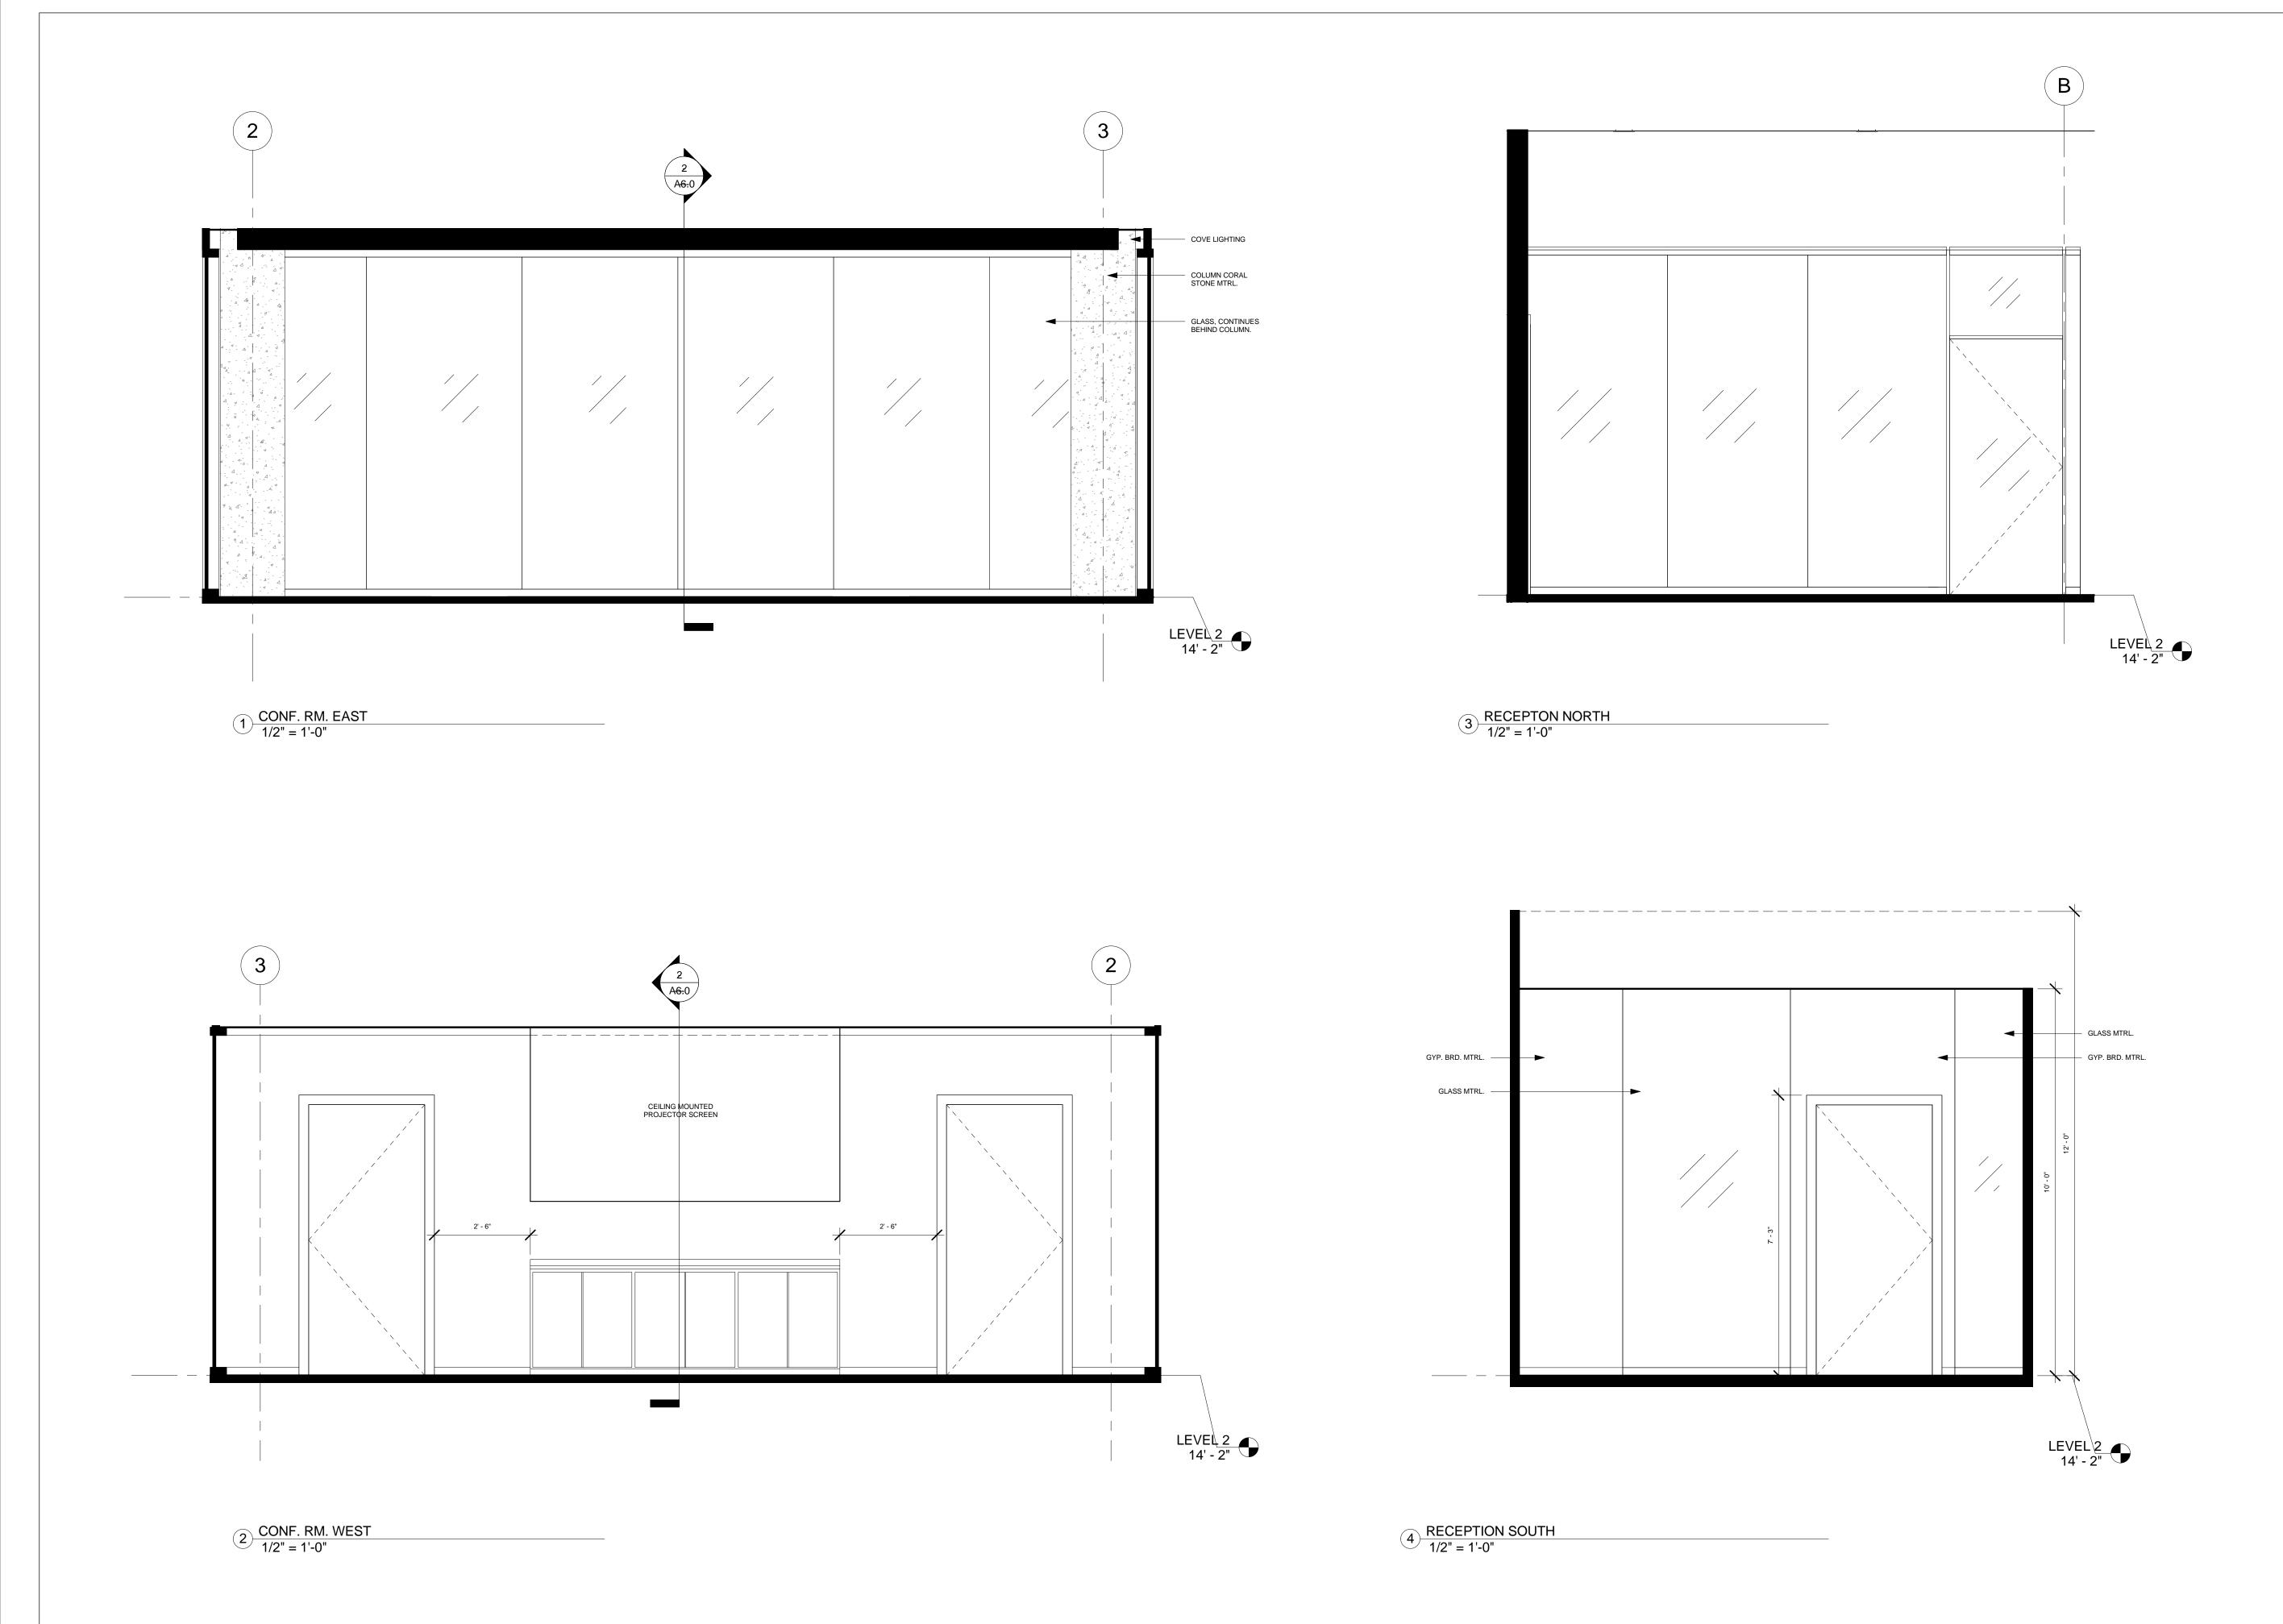

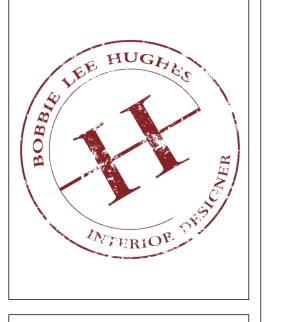

NATIONAL GEOGRAPHIC

NAL GEOGRAPHIC HEADQUARTERS 34 GRAHAM STREET SAN FRANCISCO, CA. 94129

INTERIOR ELEVATIONS

Project number 00004


Date MAY 25, 2017

Drawn by BLH

Checked by SS

A5.4

1/2" = 1'-0"

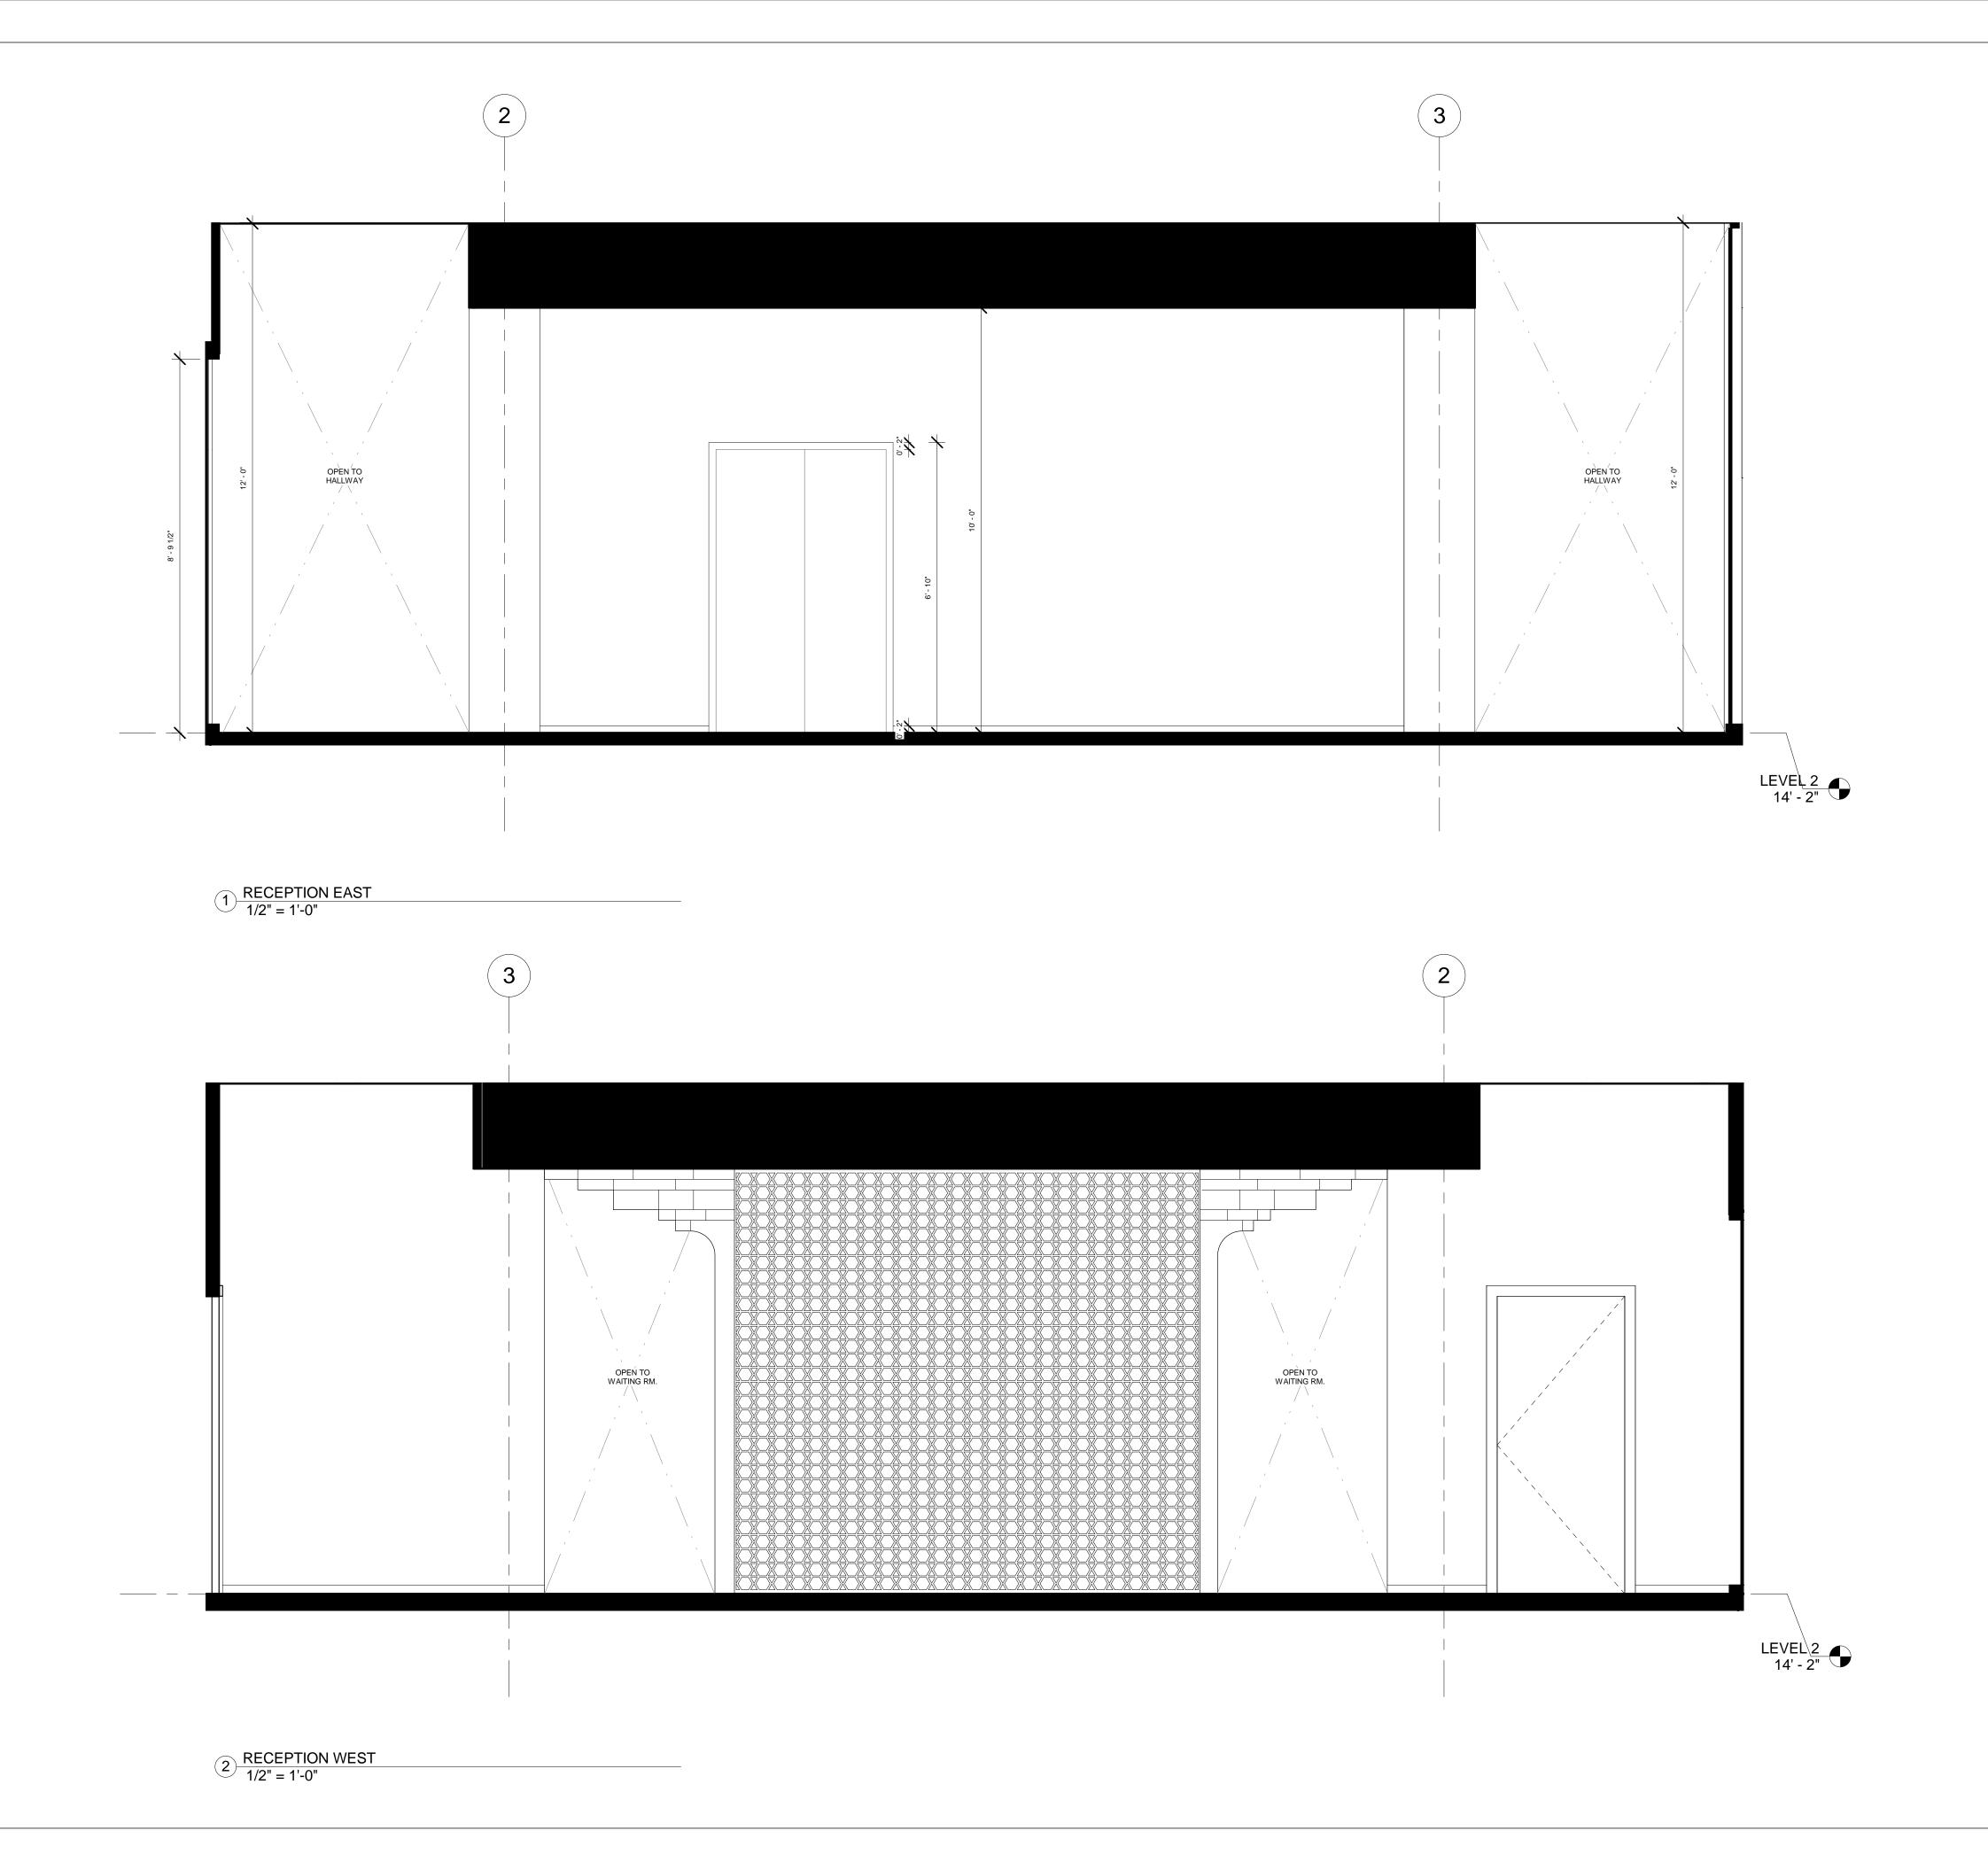




NATIONAL GEOGRAPHIC

INTERIOR ELEVATIONS

Project number 00004
Date MAY 25, 2017
Drawn by BLH
Checked by SS

A5.5

Scale 1/2" = 1'-0"

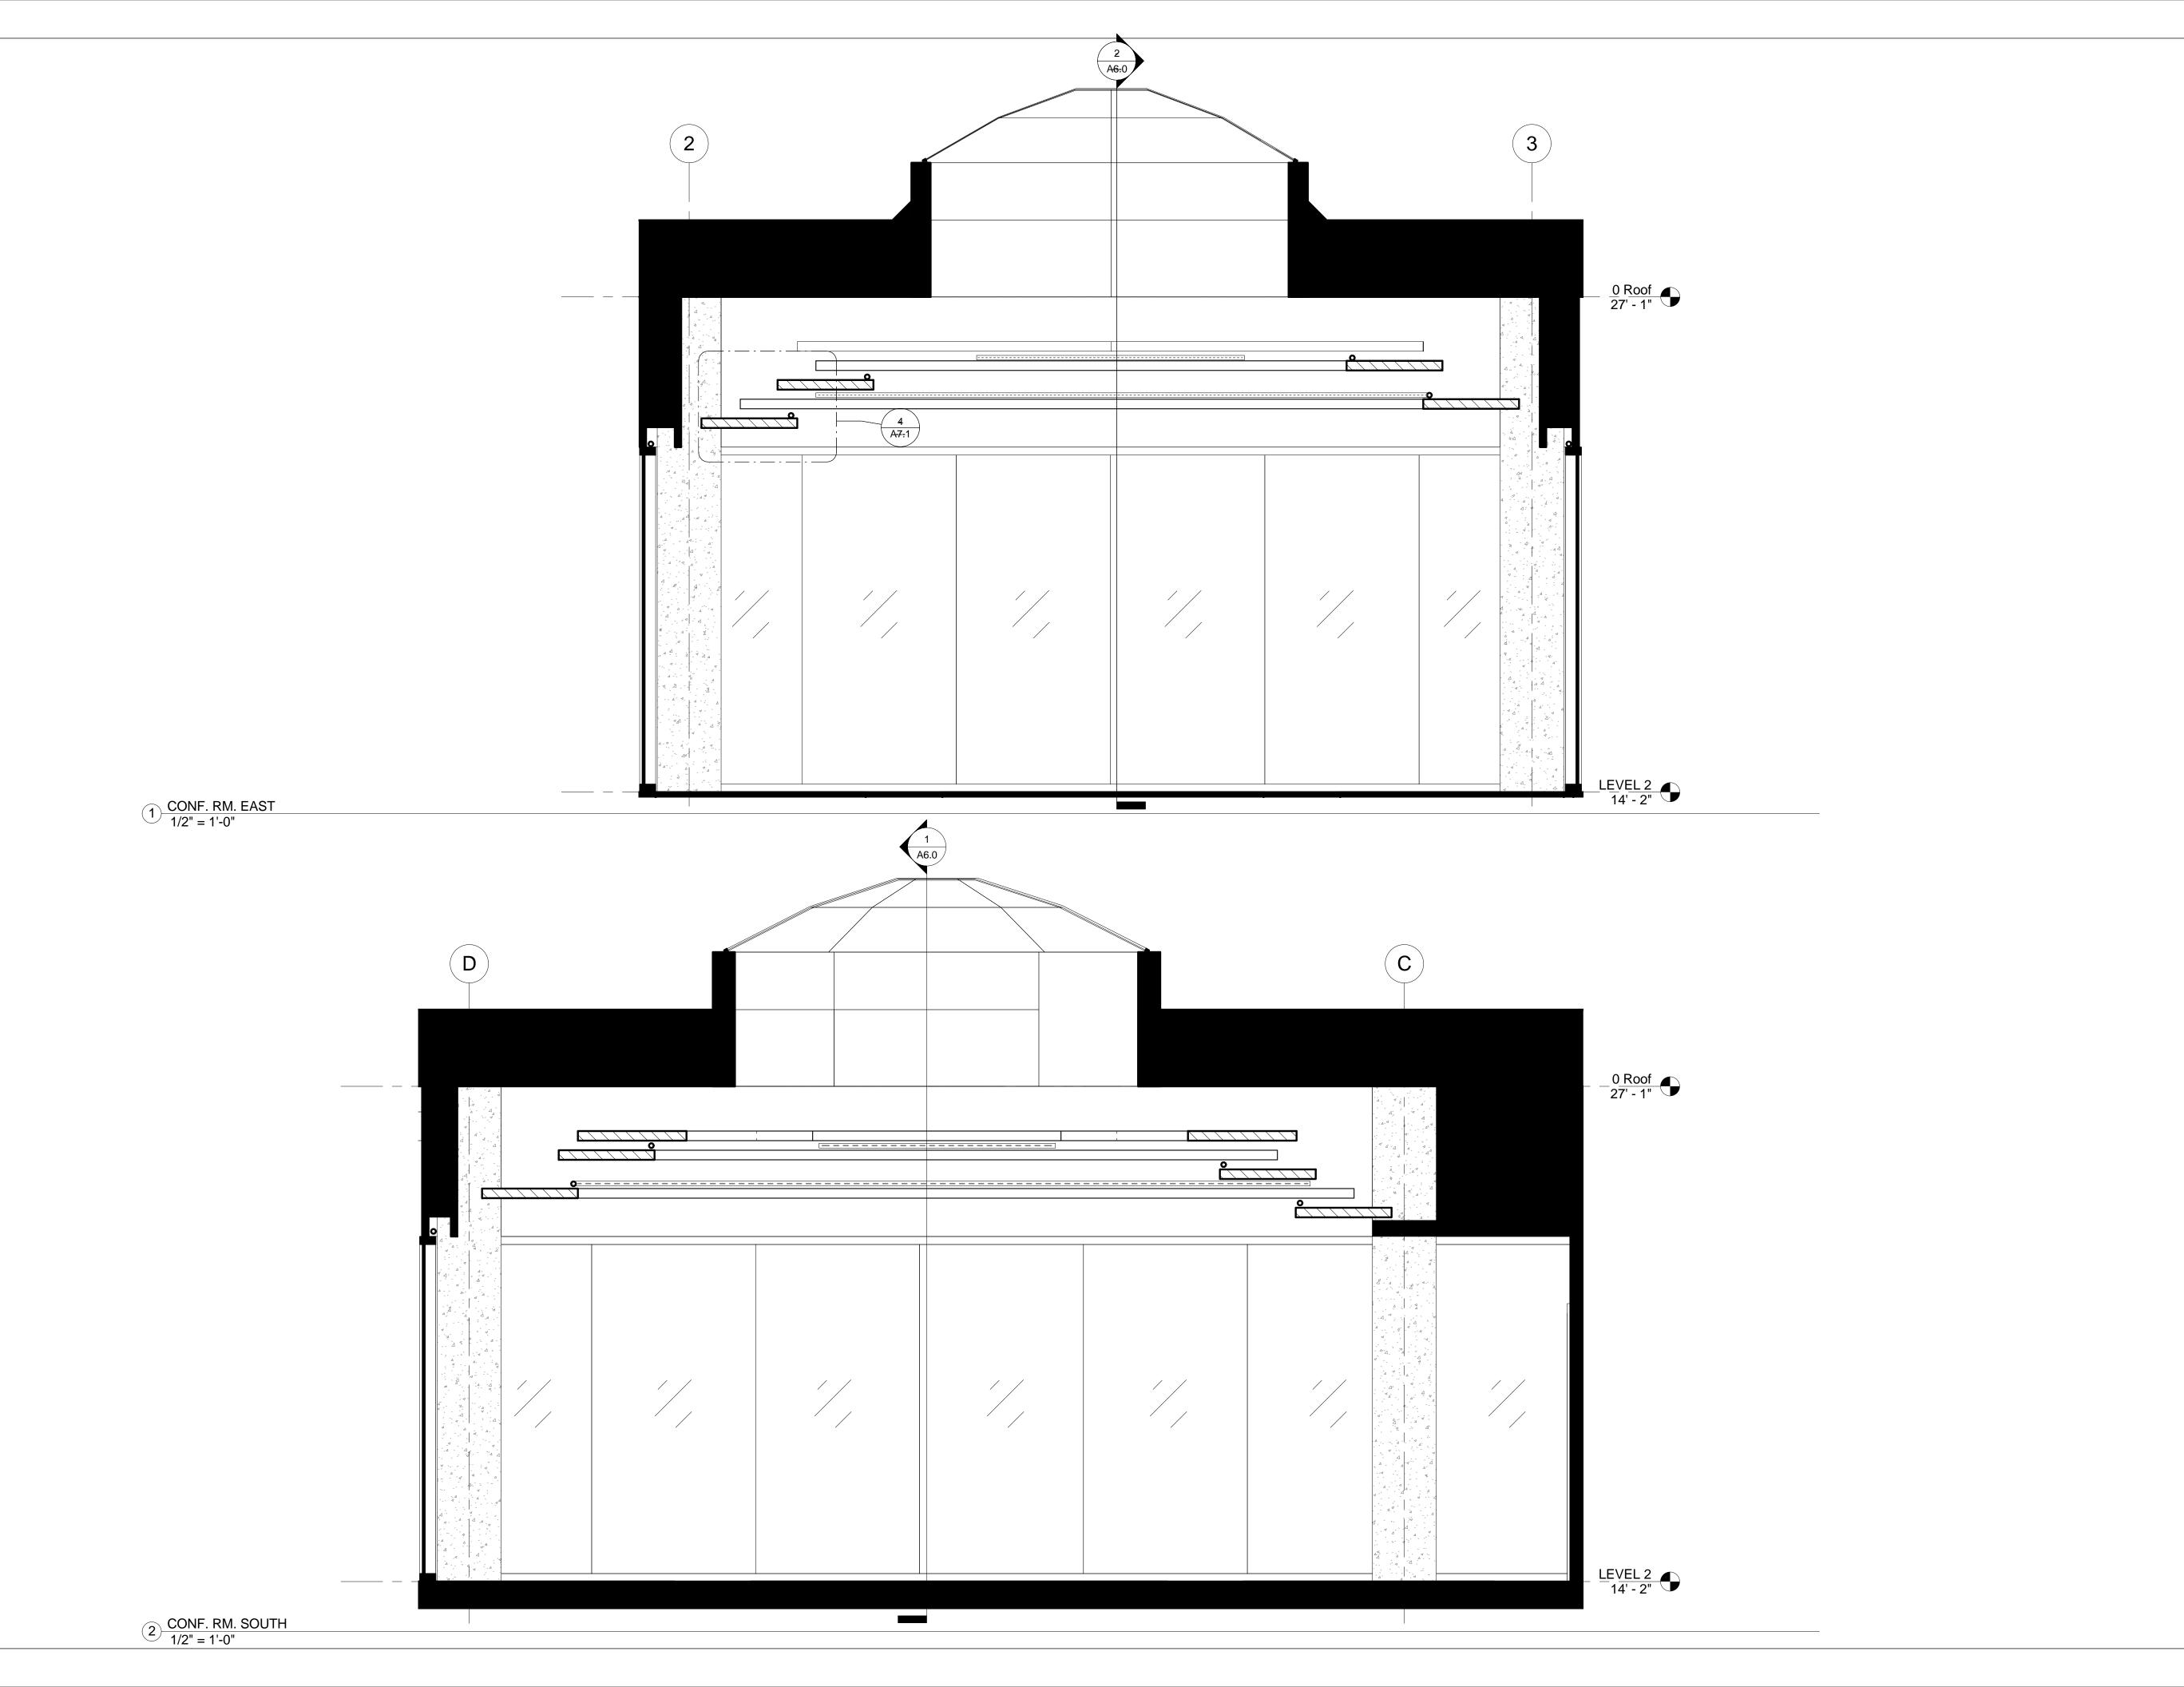

NATIONAL GEOGRAPHIC HEADQUARTERS 34 GRAHAM STREET SAN FRANCISCO, CA. 94129

GEOGRAPHIC
SECTIONS


Project number 00004


NATIONAL


Date MAY 25, 2017
Drawn by BLH
Checked by SS

A6.0

1/2" = 1'-0"

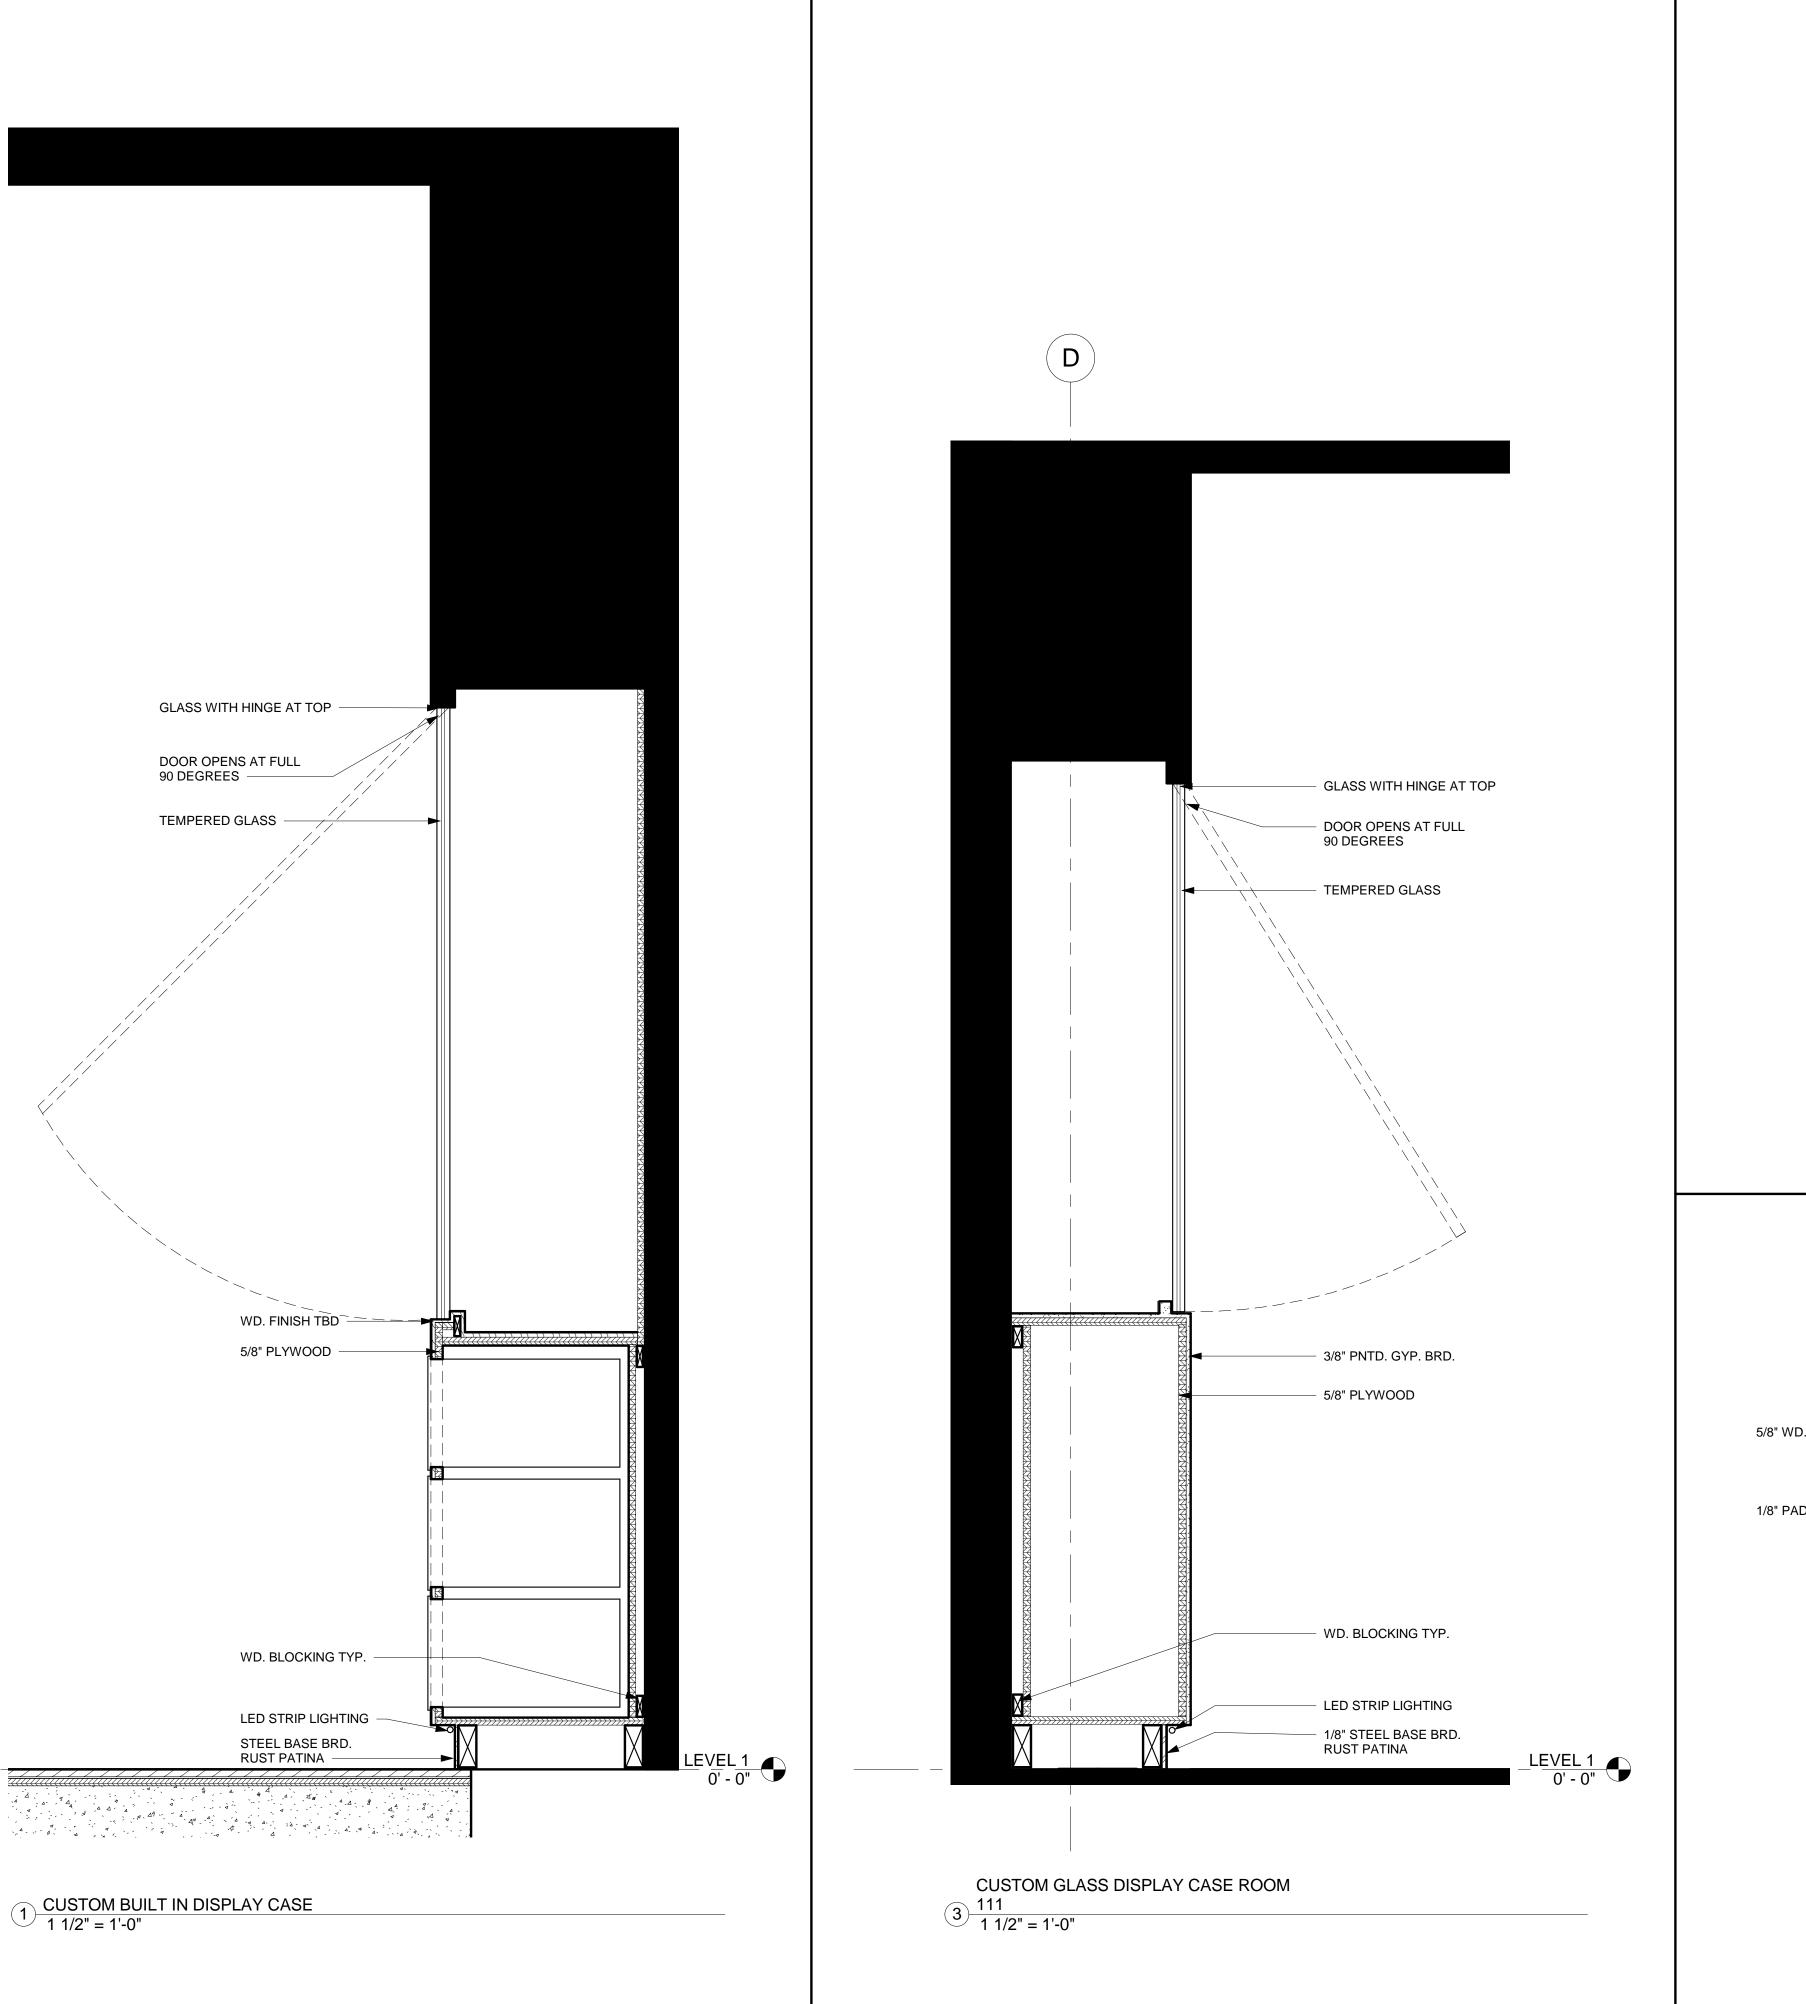

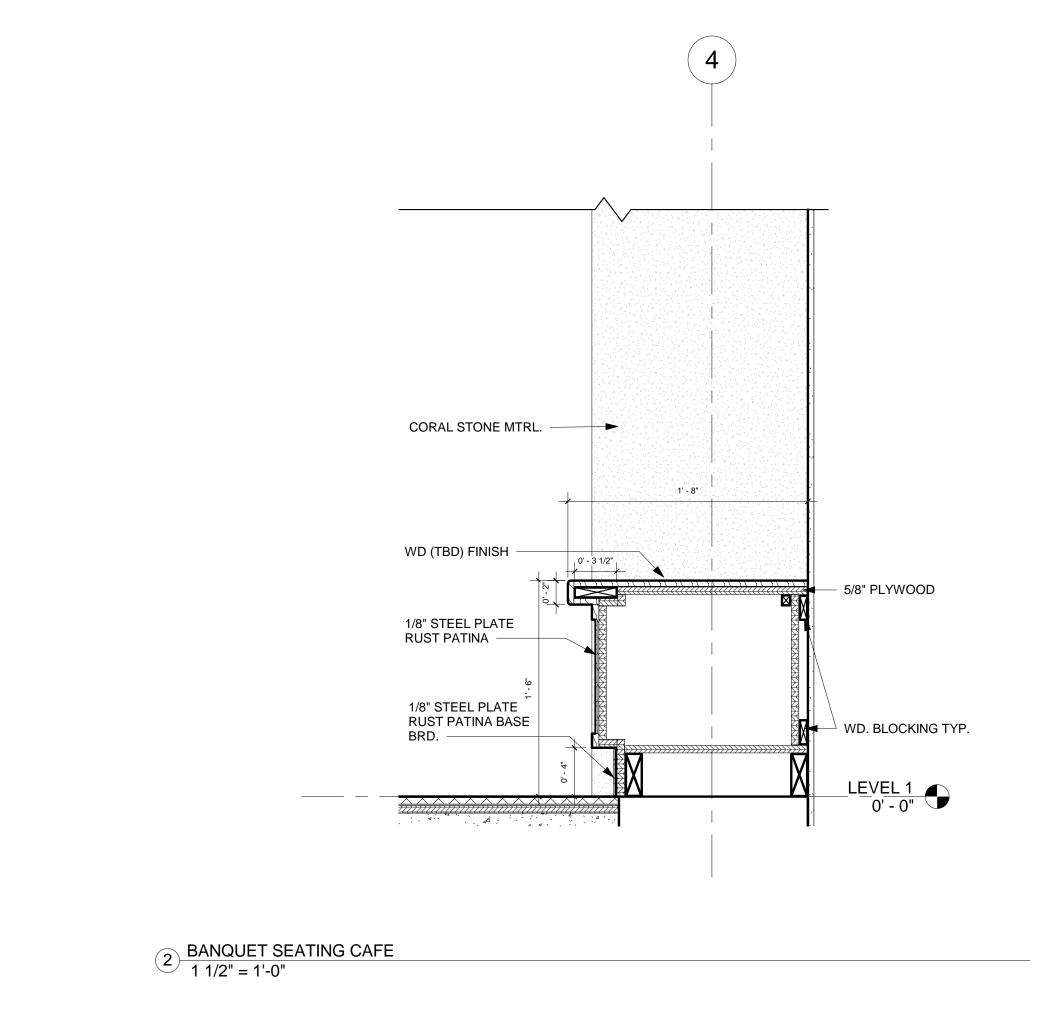

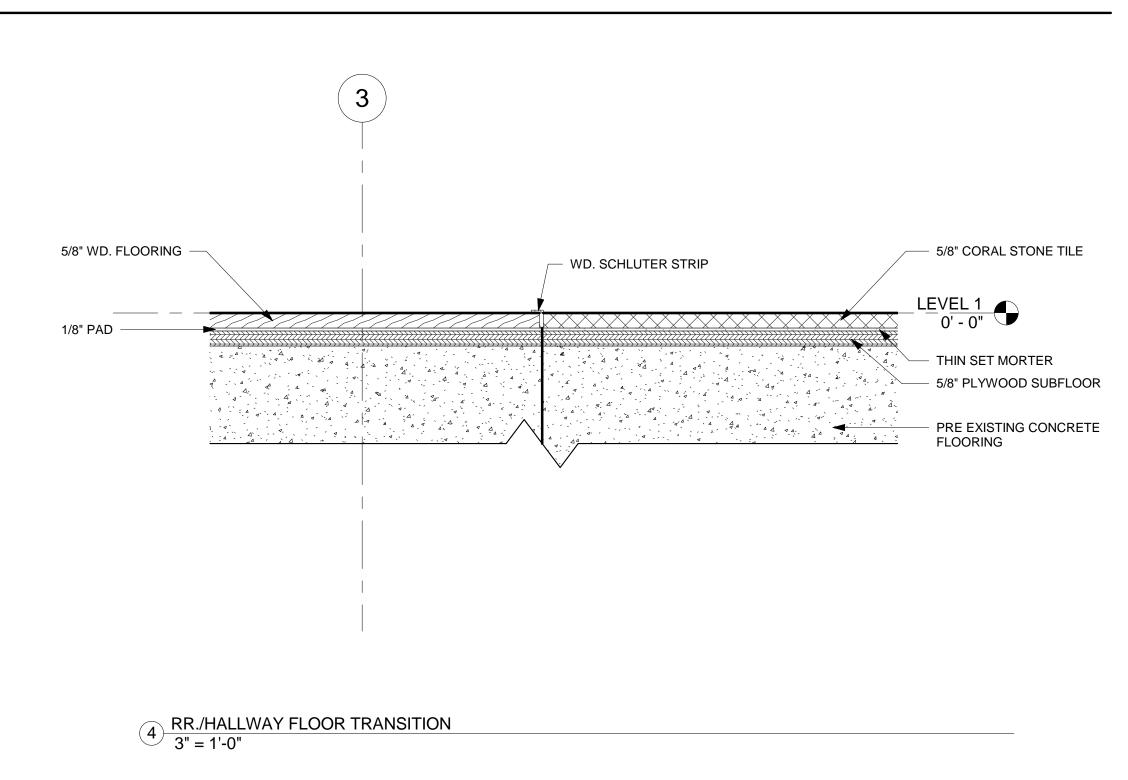



NATIONAL GEOGRAPHIC

DETAILS


Project number 00004


Date MAY 25, 2017

Drawn by BLH

Checked by SS

A7.0
As indicated

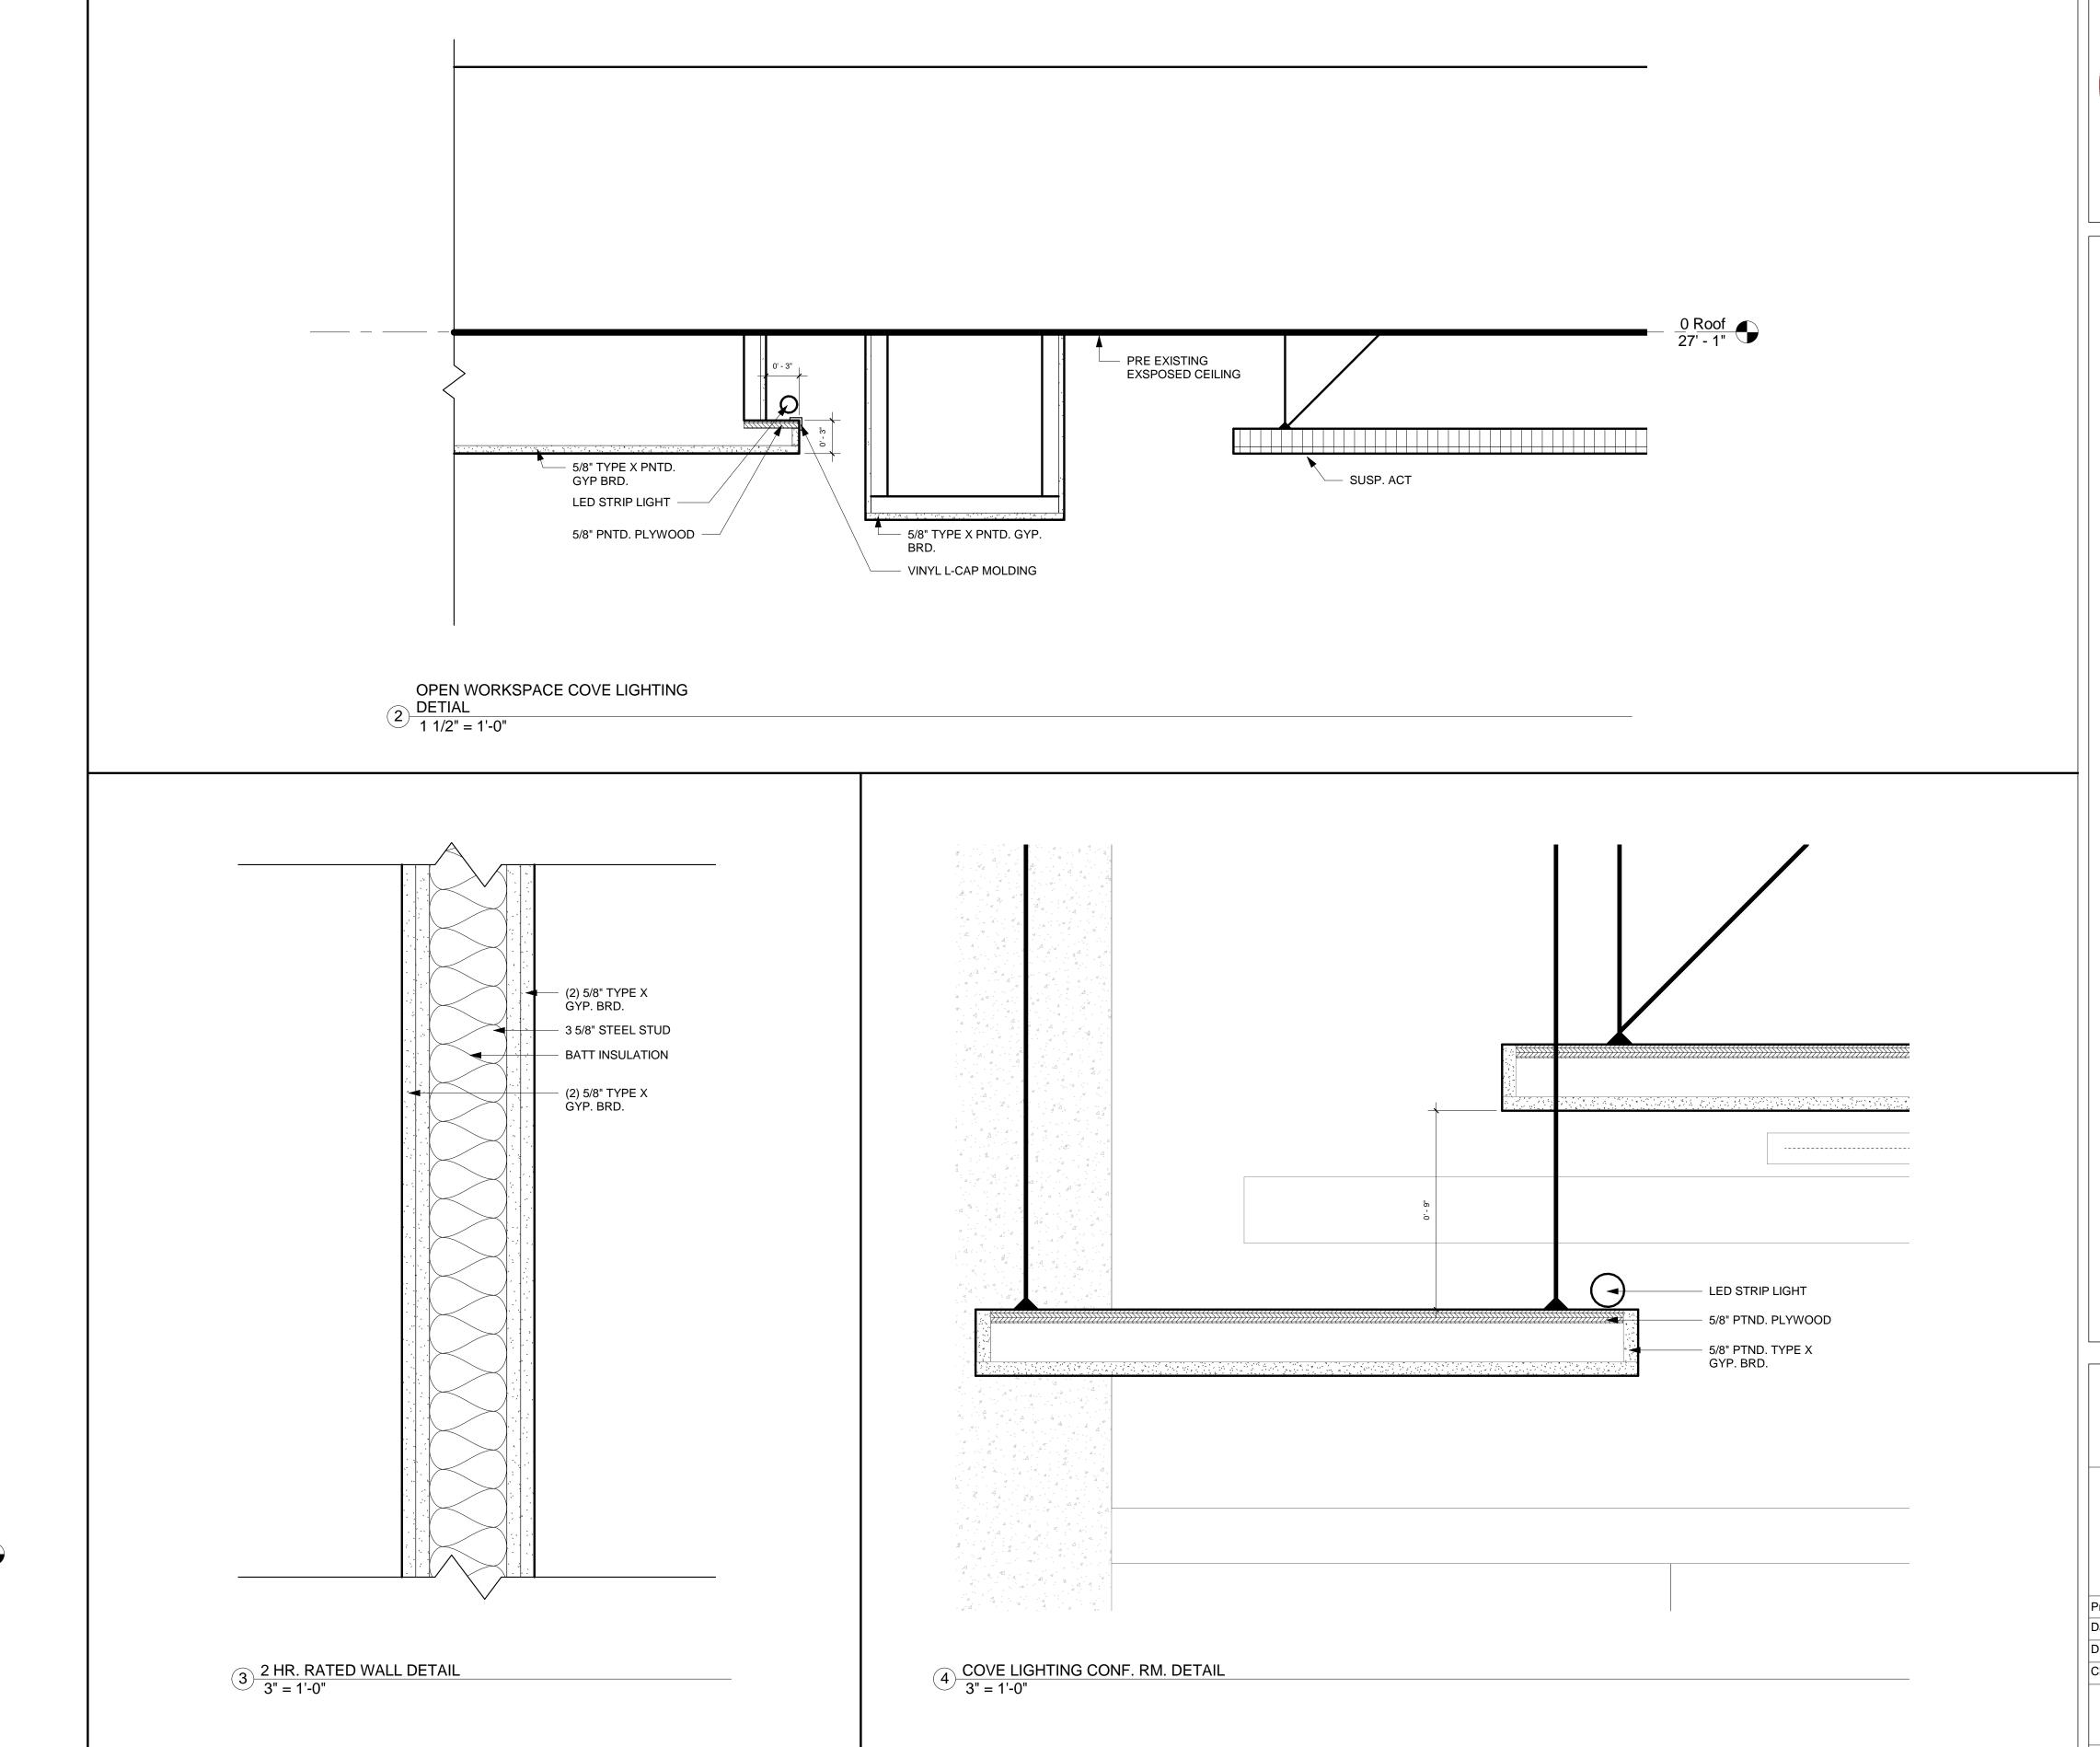

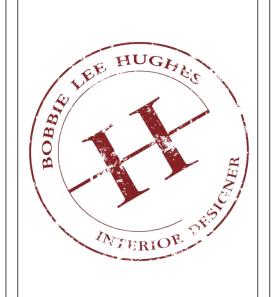

NATIONAL GEOGRAPHIC HEADQUARTERS 34 GRAHAM STREET SAN FRANCISCO, CA. 94129

NATIONAL GEOGRAPHIC

DETAILS

Project number 00004

Date MAY 25, 2017

Drawn by BLH

Checked by SS

A7.1
As indicated

SCREEN BEHIND REC. DESK DETAIL
1 1/2" = 1'-0"


- PTND. TYPE X GYP. BRD.

— STAINED GLASS


- CUSTOM WD. SCREEN.

NEOPRENE GLAZING GASKET

CUSTOM WD. SCREEN.

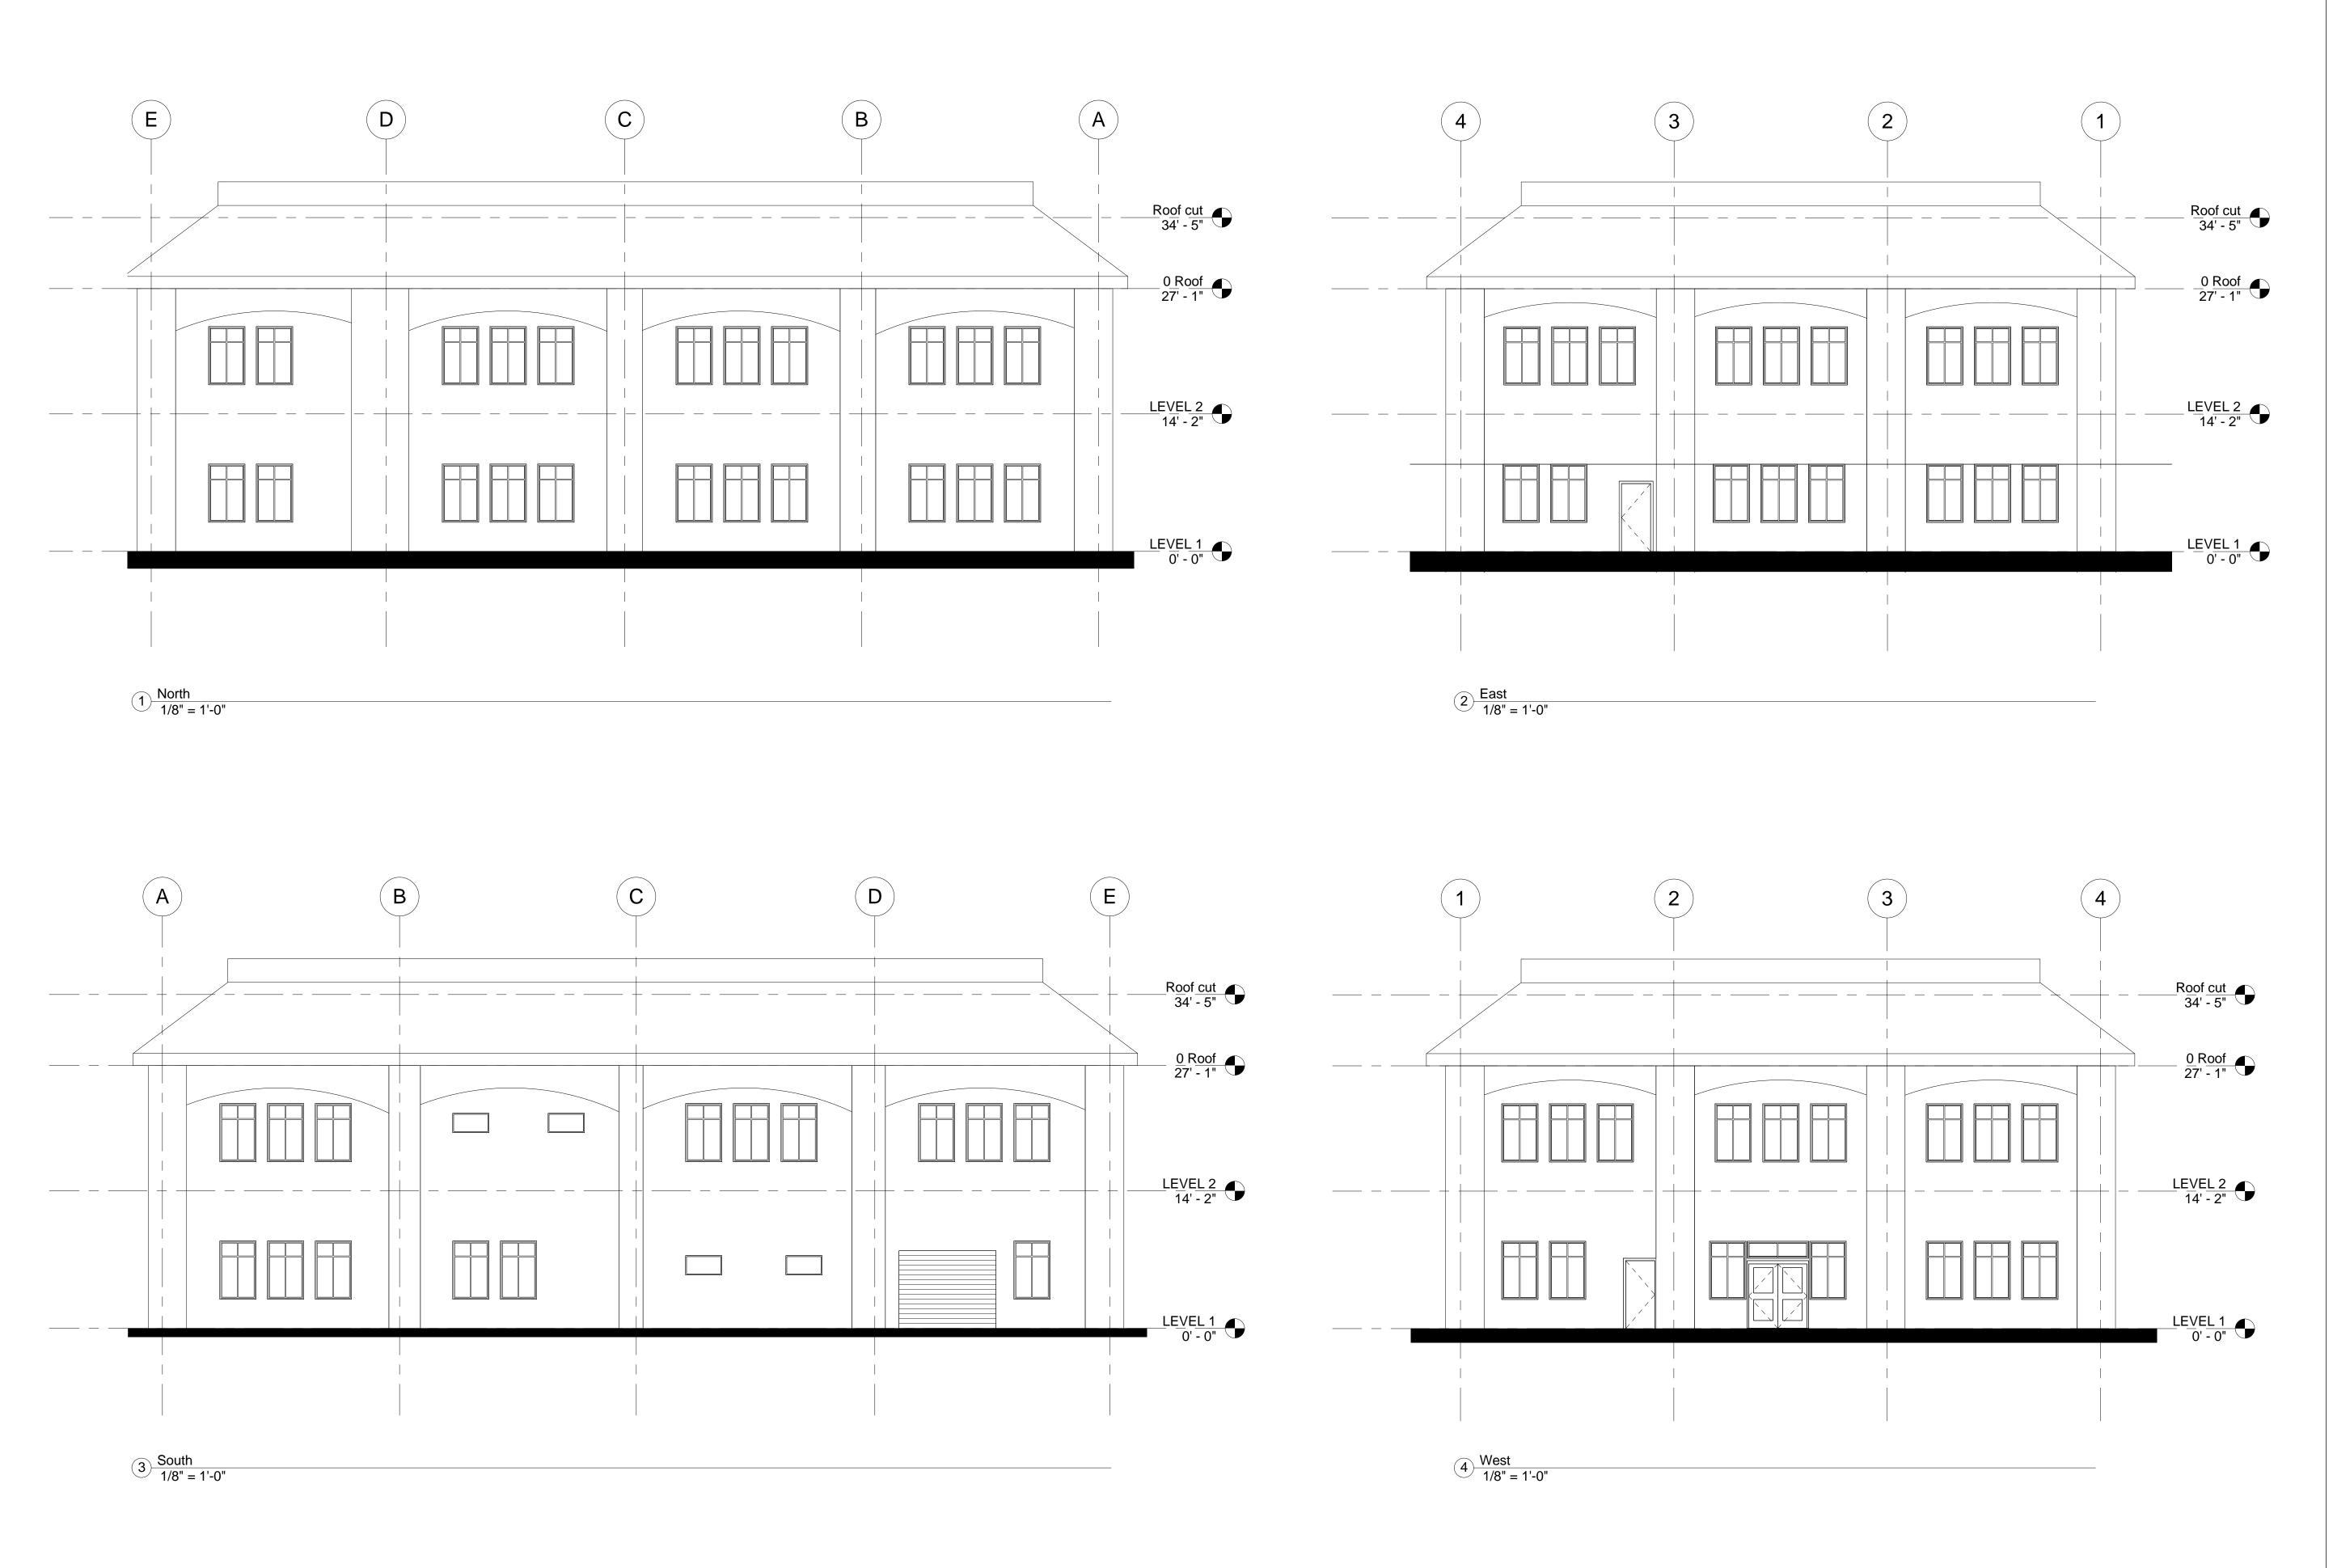



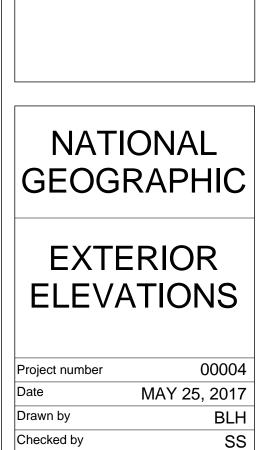

A8.0

1/8" = 1'-0"

Scale